





### GIFTED ASSETS

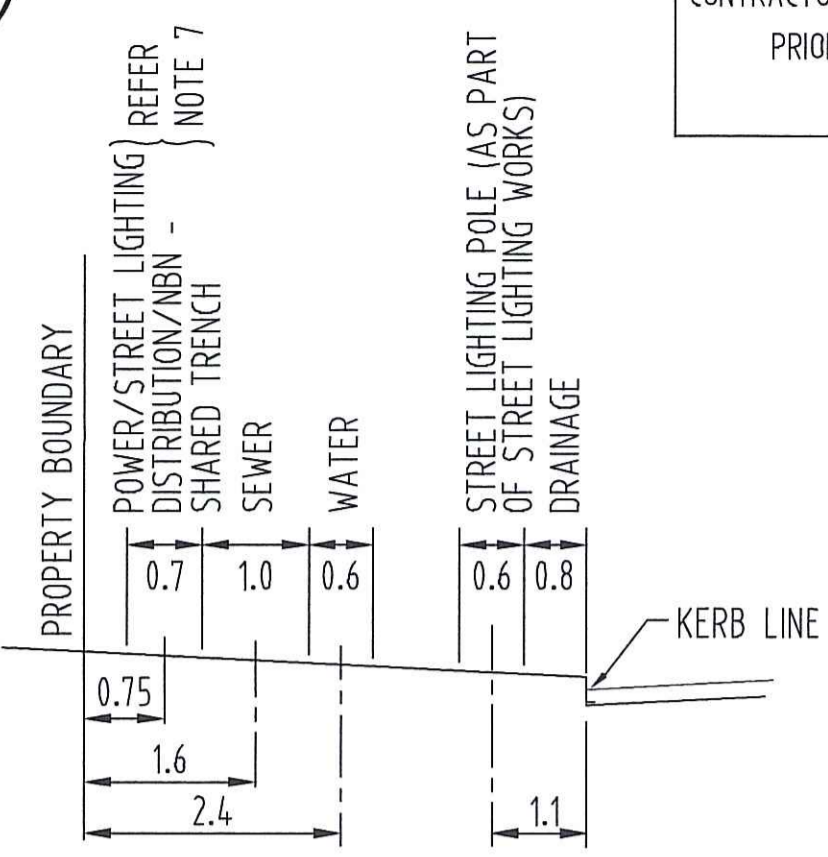

DETAIL A - ALLOCATION FOR SERVICES N.T.S.  
NOTE: DIMENSIONS IN METRES

**WARNING**  
BEWARE OF EXISTING UNDERGROUND SERVICES.  
CONTRACTOR SHALL CONFIRM LOCATIONS OF SERVICES  
PRIOR TO EXCAVATION. COORDINATE WITH  
ALL RELEVANT AUTHORITIES.

### ANTICIPATED CONSTRUCTION COMMENCEMENT DATE NOVEMBER 2023

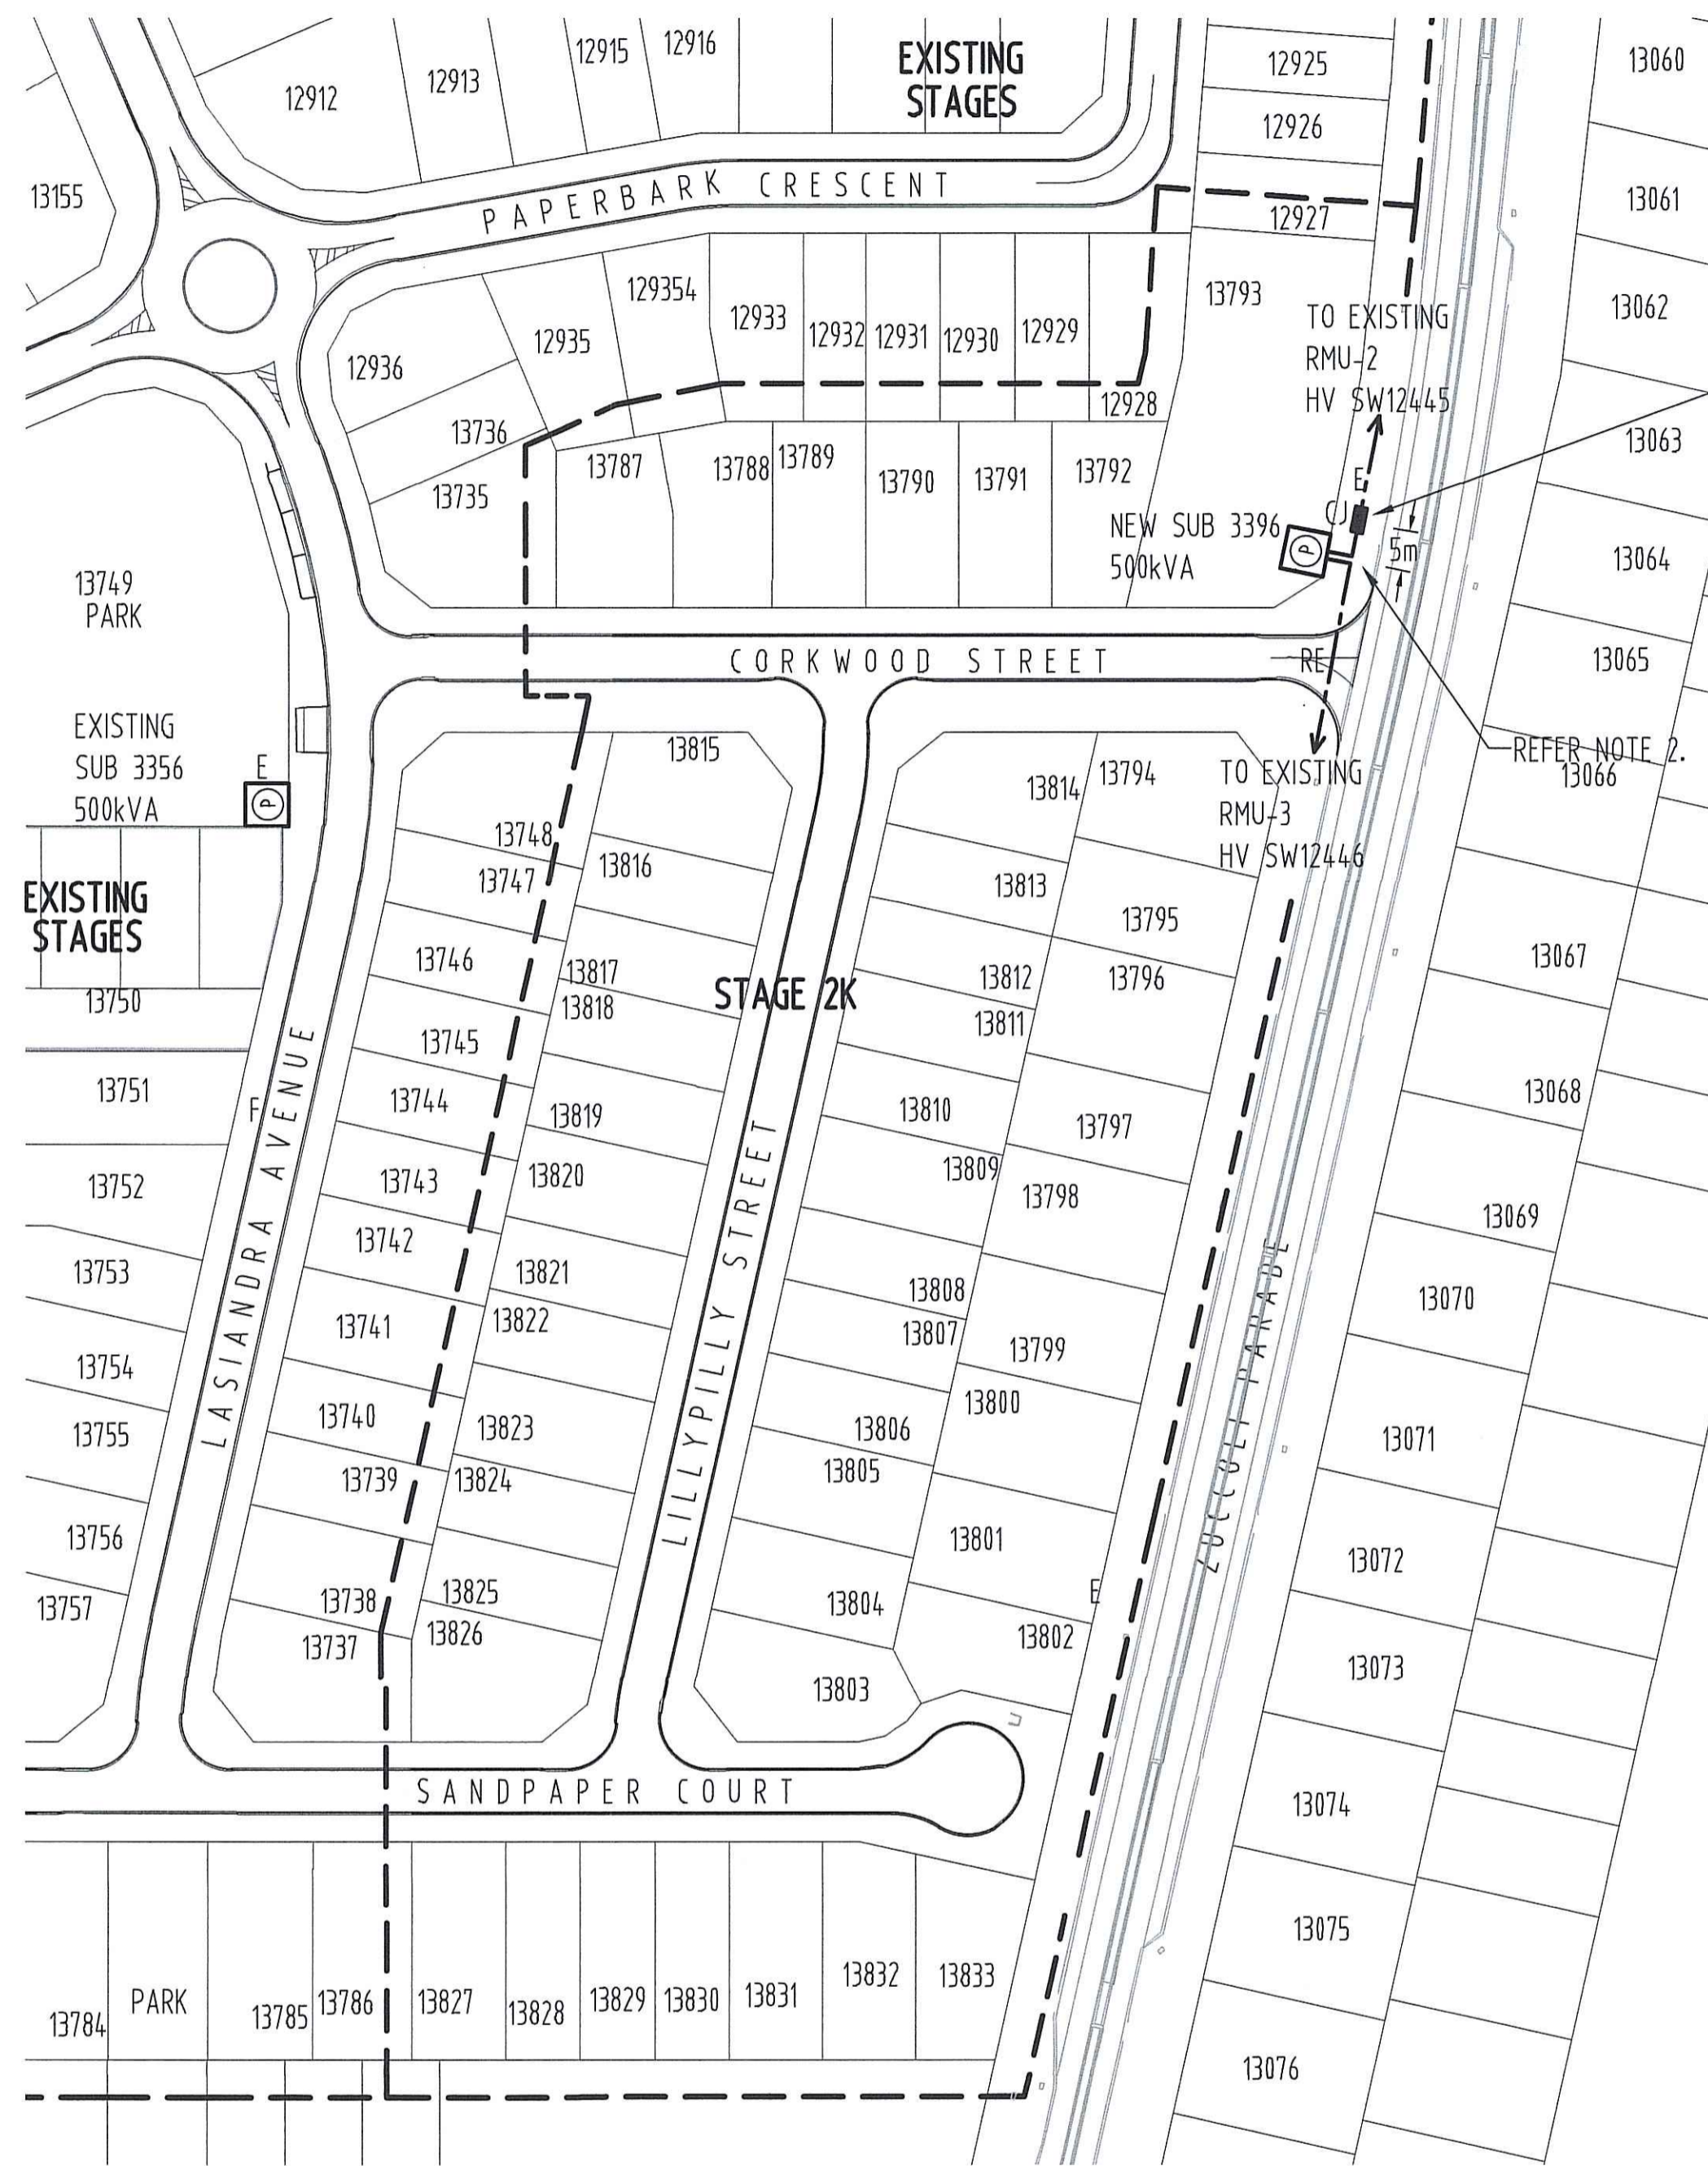

SITE PLAN (1:1000 AT A1)

**POWER AND WATER  
INSTRUCTIONS TO DEVELOPER**  
The Developer shall ensure that any Contractor employed to carry out work on this electrical reticulation is accredited by Power and Water for the particular work.  
The Contractor shall only carry out work in accordance with the approved drawings and the "Design and Construction of Network Assets" requirements.


CONTRACTOR SHALL ARRANGE FOR POWER AND WATER TO LOCATE EXISTING HV CABLE (BETWEEN EXISTING RMU-2 HV SW12445 AND EXISTING RMU-3 HV SW12446) CONTRACTOR SHALL THEN EXCAVATE & EXPOSE EXISTING CONDUITS. CONTRACTOR SHALL LEAVE SUFFICIENT LENGTH NEW HV CABLE (FROM NEW SUB 3396, HV SW21888) COILED IN NEW SAND PIT SP2. POWER AND WATER TO CUT EXISTING HV CABLE (BETWEEN RMU-2 HV SW12445 AND RMU-3 HV SW12446 IN NEW CJSP), PULL BACK ONE END (FROM EXISTING RMU-3 HV SW12446) TO NEW SAND PIT SP3, THEN PULL BACK THROUGH NEW 1x150mm HD uPVC CONDUIT AT NEW ROAD CROSSING (BETWEEN NEW SP2/SP3 TO NEW SAND PIT SP2) THEN THROUGH NEW 3x100mm HD uPVC CONDUITS BETWEEN NEW SP2/SUB 3396), THEN PULL INTO NEW SUB 3396 HV SECTION & CONNECT/TERMINATE TO NEW HV SW21887. EXTEND NEW HV CABLE (FROM NEW SUB 3396 HV SW21888) LEFT COILED IN NEW SAND PIT SP2 TO NEW CJSP IN EXISTING 1x150mm HD uPVC CONDUIT VACATED ONCE EXISTING HV CABLE REMOVED & JOINT TO EXISTING HV CABLE (FROM EXISTING RMU-2 HV SW12445). CONTRACTOR SHALL THEN BACKFILL/COMPACT TRENCH.

### NOTES


- 1 - REFER DWG No. B23-7113 FOR DETAILS OF ITEMS LISTED IN LEGEND.
- 2 - CONTRACTOR SHALL LOCATE EXISTING EARTH CABLING IN LOCATIONS SHOWN, JOINT NEW 1x1C 70 Sq mm Cu, BARE EARTH CABLING & EXTEND TO AND CONNECT TO NEW SUB 3396.
- 3 - CONTRACTOR SHALL LEAVE SUFFICIENT LENGTH NEW HV CABLING (FROM NEW SUB 3396 HV SW21888) COILED WITHIN NEW SAND PIT SP2 & ARRANGE FOR POWER AND WATER TO CUT EXISTING HV CABLE (BETWEEN EXISTING RMU-2 HV SW12445 AND RMU-3 HV SW12446 IN CJSP) AND JOINT ONE END (FROM RMU-2 HV SW12445 TO NEW HV CABLE (FROM NEW SUB 3396 HV SW21888) AND THEN PULL BACK OTHER END TO NEW SAND PIT SP3 AND PULL INTO NEW SUB 3396 HV SECTION VIA NEW 1x150mm HD uPVC CONDUIT AT NEW ROAD CROSSING BETWEEN NEW SP2/SP3, THEN VIA NEW 3x100mm HD uPVC CONDUITS BETWEEN NEW SP2/NEW SUB 3396 & CONNECT/TERMINATE NEW HV CABLING TO HV SW21887.
- 4 - NEW SUB 3396 FOUNDATION SHALL BE INSTALLED AT AN APPROPRIATE LEVEL THAT IT WILL NOT BE DETRIMENTALLY AFFECTED BY RUN OFF STORMWATER.
- 5 - PRIOR TO COMMENCING WORK ON SITE, CONTRACTOR SHALL OBTAIN RELEVANT PERMITS (AND PAY ANY ASSOCIATED COSTS) & LIAISE WITH ALL RELEVANT AUTHORITIES TO ENSURE ALL EXISTING UNDERGROUND SERVICES ARE LOCATED (PRIOR TO TRENCH EXCAVATION WITHIN EXISTING ROAD RESERVE).
- 6 - HV CABLING SHALL BE RUN BELOW (DEEPER THAN STANDARD ELECTRICAL TRENCH DEPTH/COVER) SEWER/DRAINAGE WITH A MINIMUM OF 300mm CLEARANCE AT CROSSOVER LOCATIONS. COORDINATE ON SITE WITH CIVIL CONTRACTOR.
- 7 - MINIMUM 300mm HORIZONTAL SEPARATION REQUIRED BETWEEN EDGE OF NBN CONDUIT/S & DIRECT BURIED LV CABLING. WHERE 300mm SEPARATION NOT PROVIDED, LV CABLING SHALL BE INSTALLED IN 100mm HD uPVC CONDUIT. ALSO REFER DETAILS B & C.

### LEGEND

- NEW PACKAGE SUBSTATION (RATING AS SHOWN). 'E' INDICATES EXISTING.
- EXISTING HV CABLE - 6.35/11kV 3x1C 400 Sq mm Al (WATER BLOCKED), XLPE/WBT/SCN/HDPE/NJ/PVC IN EXISTING 150mm HD uPVC CONDUIT & EXISTING 1x1C 70 Sq mm Cu, BARE EARTH DIRECT BURIED.
- RELOCATED EXISTING HV CABLE - 6.35/11kV 3x1C 400 Sq mm Al (WATER BLOCKED), XLPE/WBT/SCN/HDPE/NJ/PVC IN NEW 150mm HD uPVC CONDUIT & NEW 1x1C 70 Sq mm Cu, BARE EARTH DIRECT BURIED BETWEEN NEW SP2/SP3 & IN NEW 3x100mm HD uPVC CONDUITS BETWEEN NEW SP1/SP2.
- NEW HV CABLE - 6.35/11kV 3x1C 400 Sq mm Al (WATER BLOCKED), XLPE/WBT/SCN/HDPE/NJ/PVC IN NEW 3x100mm HD uPVC CONDUITS & NEW 1x1C 70 Sq mm Cu, BARE EARTH DIRECT BURIED BETWEEN NEW SP1/SP2 & IN EXISTING 1x150mm HD uPVC CONDUIT VACATED ONCE EXISTING HV CABLE REMOVED BETWEEN NEW SP2/CJSP & EXISTING 1x1C 70 Sq mm Cu, BARE EARTH DIRECT BURIED.
- NEW HV CABLE JOINTS - BY POWER AND WATER.

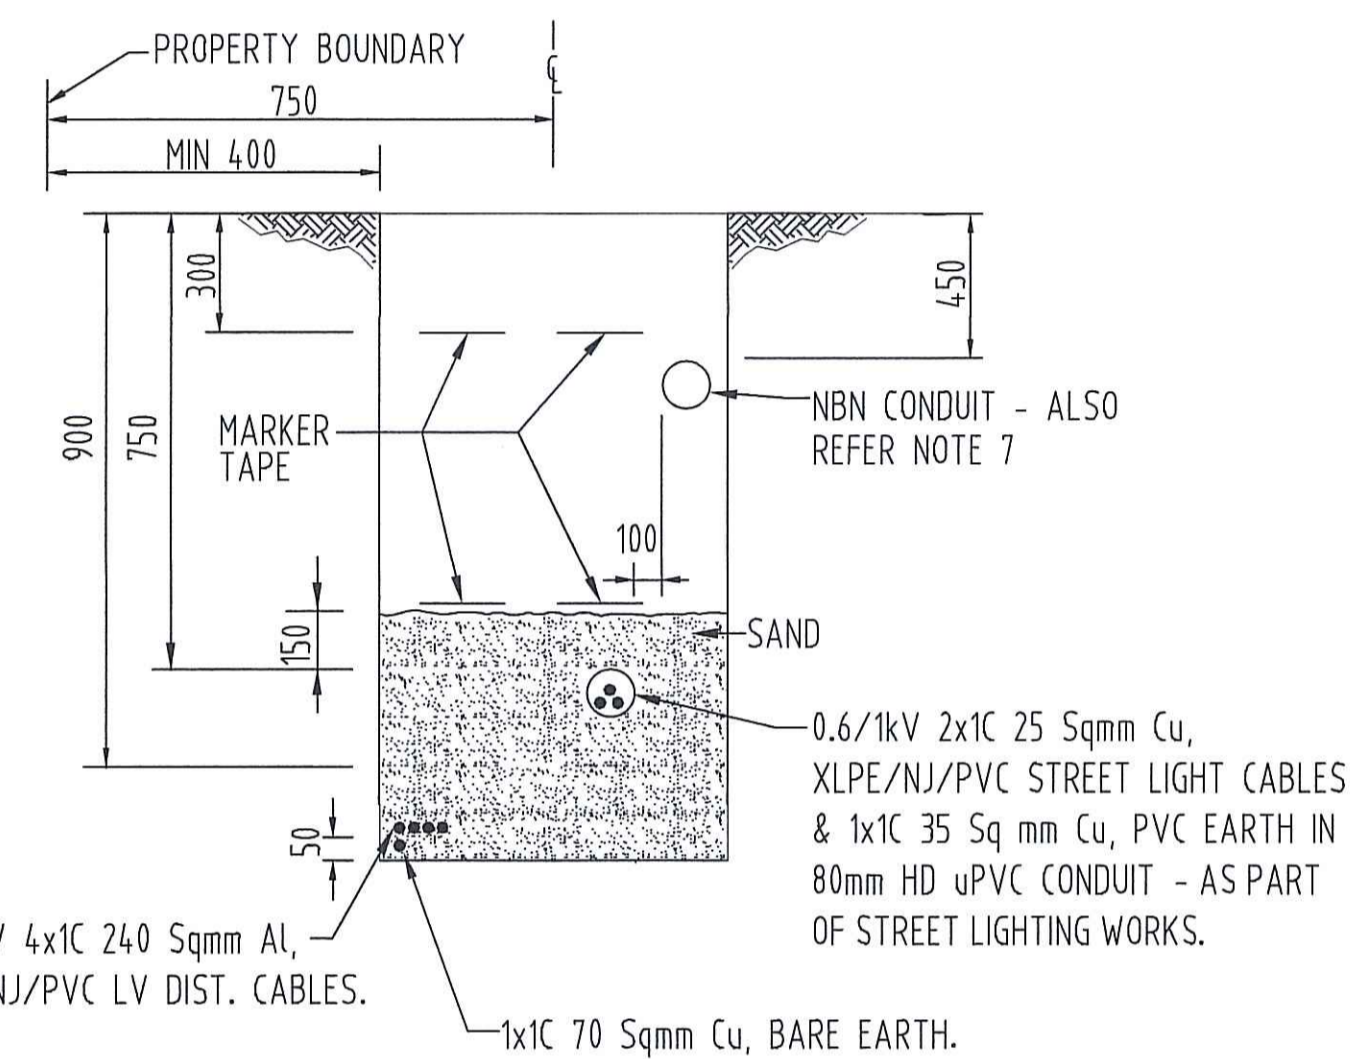


DETAIL B - TYPICAL CABLE TRENCH DETAIL (N.T.S.)

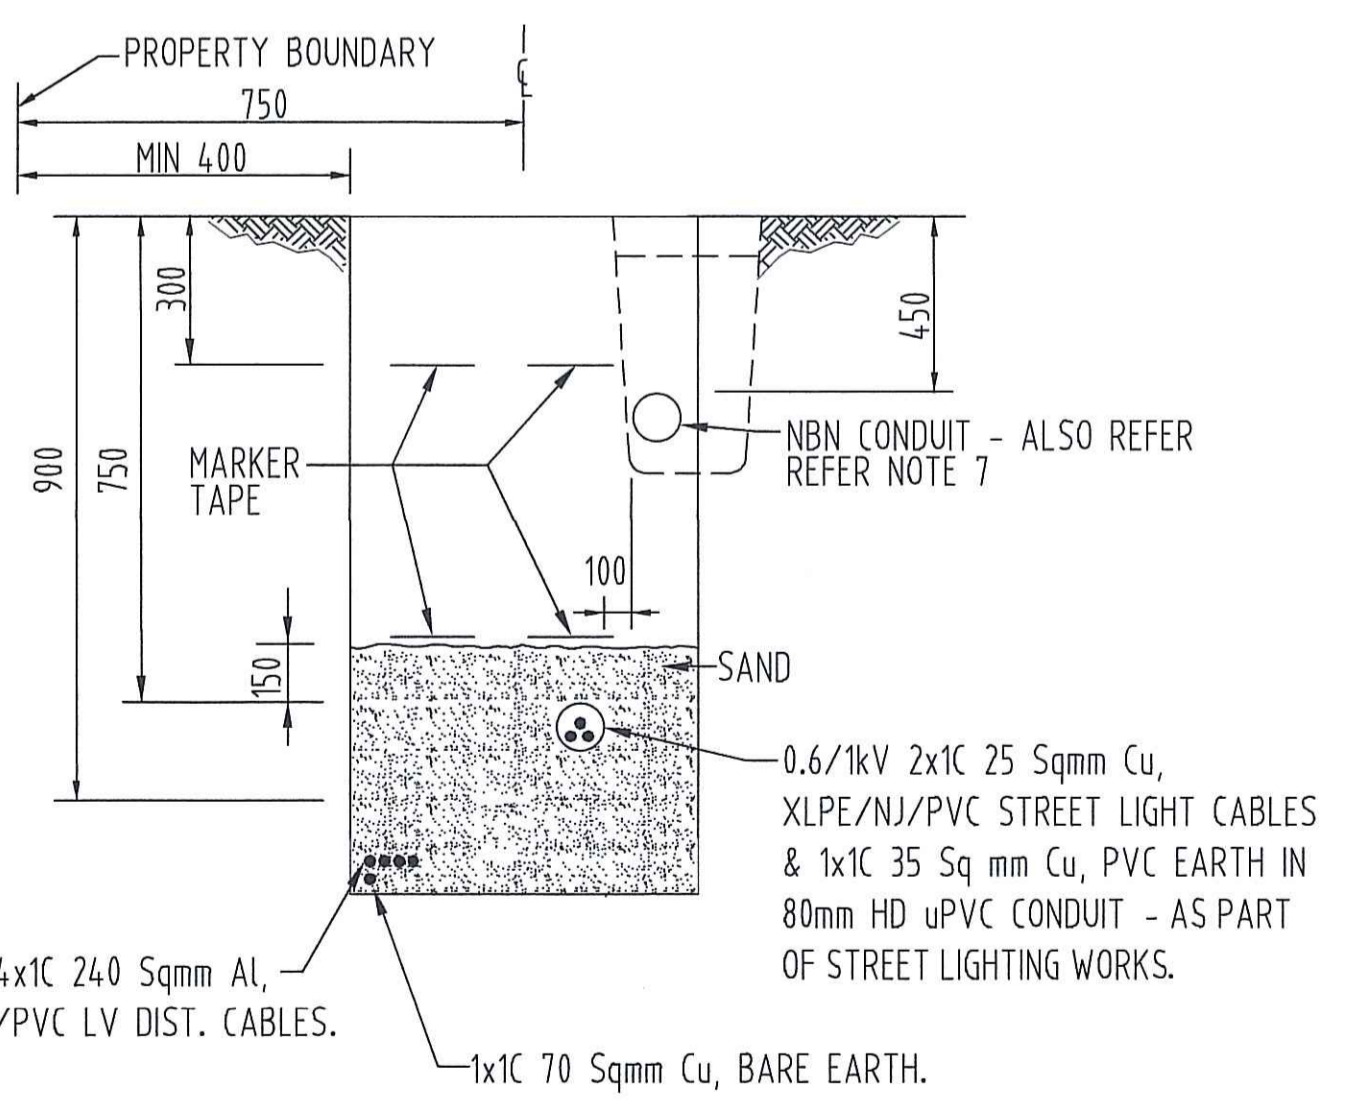

DETAIL C - TYPICAL CABLE TRENCH WITH NBN PIT (N.T.S.)

**POWER AND WATER**  
This drawing has been endorsed in principal for electrical construction in respect of:  
\* High Voltage reticulation details  
\* Low Voltage reticulation details  
\* Substation & transformer details  
\* Cable and cabling details  
This endorsement is issued on the Consultant certifying that the design complies with Power and Water's requirements, in the absence of any trademark and existing services have been checked on the design. The design is not a final design and should not be construed as a final design. The design is not a final design and should not be construed as a final design. The design is not a final design and should not be construed as a final design. This responsibility is absolute with the Developer's electrical consultant.  
This endorsement remains valid for 12 months from the date of issue. Should this period be exceeded prior to commencement of work, or any significant change have been made, drawings must be re-submitted for endorsement in accordance with current standards.  
Endorsement is subject to the conditions listed below.  
Signed: Network Engineering Date: 29 Sep 23

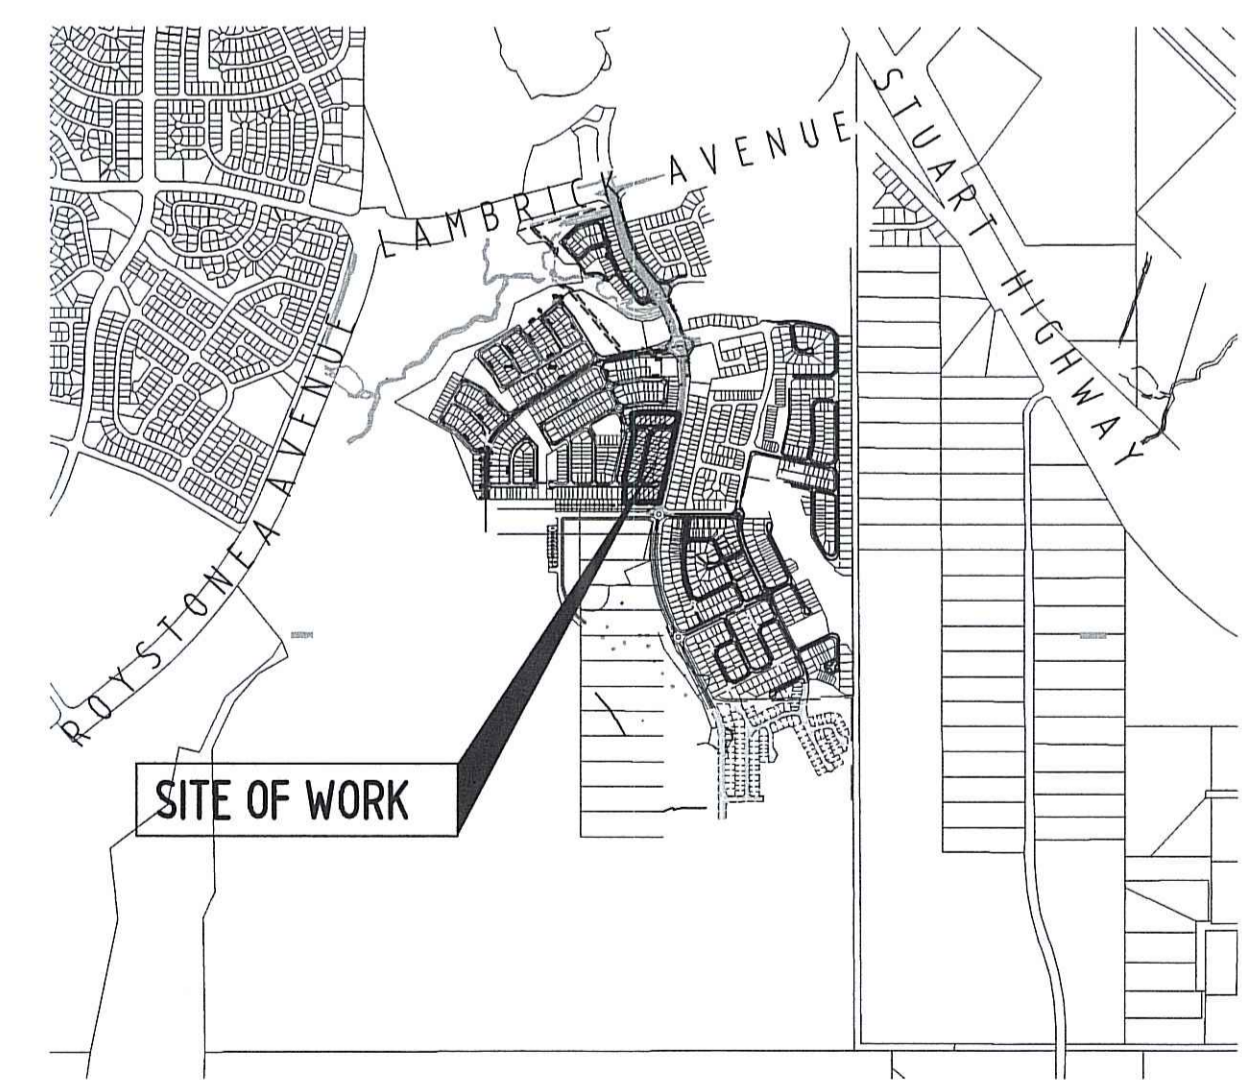

LOCALITY PLAN (N.T.S.)

DEVELOPER:  
**TERRITORY LIFE**  
GPO Box 1779  
DARWIN NT 0801

PHONE: 0417 160780  
FACSIMILE:  
EMAIL: clement.williams@territorylife.com.au  
CONTACT: CLEMENT WILLIAMS

**AGA CONSULTING ENGINEERS PTY LTD**  
ELECTRICAL & MECHANICAL  
ACN 070 262 296

GPO BOX 3097  
DARWIN NT 0801

TELEPHONE: 08 89416582  
FACSIMILE: 08 89427400  
EMAIL: ciek@agang.com.au

NO	DESCRIPTION	DRN	DATE	APPD	DRG NO	TITLE
C	RE-ISSUED FOR POWER AND WATER APPROVAL		25-9-23	A.G.	B23-7114	SINGLE LINE DIAGRAM & LEGEND NOTES, SCHEDULES & HV SCHEMATICS MASTER SERVICES PLAN CONDUIT/DUCT LAYOUT LV ELECTRICAL RETICULATION
B	RE-ISSUED FOR POWER AND WATER APPROVAL		15-9-23	A.G.	B23-7112	
A	ISSUED FOR POWER AND WATER APPROVAL		29-6-23	A.G.	B23-7111	

DRAWING STATUS	APPD	DATE
P PRELIMINARY/PROPOSED		
T TENDERING PURPOSES ONLY		
AC APP. FOR CONSTRUCTION		
AI AS INSTALLED		
C CANCELLED/SUPERSEDED		

ASSOCIATED DRAWINGS  
AGA406-18A



DES	A.GANGUR	POWER SERVICES - PALMERSTON DISTRIBUTION
DRN	K.TAVENER	SUBDIVISION OF LOT 12087
CKD	A.GANGUR	ZUCCOLI SUBDIVISION - STAGE 2 : STAGE 2K
APPD		HV ELECTRICAL RETICULATION
SCALE	AS SHOWN	
ISSUED	25-9-23	
ALL DIM. IN mm		
DRAFTING STANDARD TO A.S.1100		

A1	DRAWING NUMBER	<b>B23-7109</b>
	FILE No:	NE590/12087



# GIFTED ASSETS


**WARNING**  
BEWARE OF EXISTING UNDERGROUND SERVICES.  
CONTRACTOR SHALL CONFIRM LOCATIONS OF SERVICES  
PRIOR TO EXCAVATION. COORDINATE WITH  
ALL RELEVANT AUTHORITIES.

## LEGEND

- NEW PACKAGE SUBSTATION (RATING AS SHOWN).  
'E' INDICATES EXISTING.
- NEW DISTRIBUTION DOUBLE LINK PILLAR - FUSED TYPE.  
'E' INDICATES EXISTING.
- NEW DISTRIBUTION LINK PILLAR - FUSED TYPE.  
'E' INDICATES EXISTING.
- NEW DISTRIBUTION PILLAR - FUSED TYPE.  
'E' INDICATES EXISTING.
- EXISTING ROAD OWNER PILLAR.
- NEW LV DISTRIBUTION CABLE - 0.6/1kV 4 x 1C 240 Sq mm Al, XLPE/NJ/PVC - DIRECT BURIED (OR WITHIN CONDUIT AT ROAD CROSSING) & 1 x 1C 70 Sq mm Cu, BARE EARTH - DIRECT BURIED. ALSO REFER NOTE 8.  
'E' INDICATES EXISTING/'RE' INDICATED RELOCATED IN NEW 100mm HD UPVC CONDUIT.
- EXISTING LV SERVICE CABLE (SUPPLY TO ROAD OWNER DIST. PILLAR).
- NEW LV CABLE JOINTS - BY POWER AND WATER.

## NOTES

- 1 - REFER DWG No. B23-7113 FOR DETAILS OF ITEMS LISTED IN LEGEND.
- 2 - CONTRACTOR SHALL LOCATE EXISTING EARTH CABLING IN LOCATIONS SHOWN, JOINT NEW 1x1C 70 Sq mm Cu, BARE EARTH CABLING & EXTEND TO AND CONNECT TO NEW DIST. PILLARS P411ZU/P417ZU/P424ZU.
- 3 - CONTRACTOR SHALL LOCATE EXISTING SAND PITS AT LOCATIONS SHOWN & INSTALL NEW LV DIST. CABLING WITHIN EXISTING SPARE 1x100mm HD UPVC CONDUIT & THEN DIRECT BURIED TO NEW DIST. PILLARS P411ZU/P424ZU.
- 4 - CONTRACTOR SHALL LOCATE EXISTING SAND PIT AT LOCATION SHOWN & INSTALL NEW LV DIST. CABLING DIRECT BURIED TO NEW DIST. PILLAR P417ZU.
- 5 - CONTRACTOR SHALL LEAVE SUFFICIENT LENGTHS NEW LV DIST. CABLING (FROM NEW DIST. PILLAR P424ZU) COILED WITHIN EXISTING SAND PIT IN FRONT OF EXISTING SUB 3356 & ARRANGE FOR POWER AND WATER TO PULL NEW LV DIST. CABLING THROUGH EXISTING SPARE 100mm SWEEP BEND INTO EXISTING SUB 3356 LV SECTION & CONNECT/TERMINATE.
- 6 - CONTRACTOR SHALL LEAVE SUFFICIENT LENGTHS NEW LV DIST. CABLING (FROM NEW DIST. PILLARS P411ZU/P417ZU) COILED WITHIN EXISTING SAND PIT IN FRONT OF EXISTING DIST. PILLARS P409ZU/P416ZU & ARRANGE FOR POWER AND WATER TO PULL NEW LV DIST. CABLING THROUGH EXISTING SPARE 1x100mm SWEEP BEND INTO EXISTING DIST. PILLARS P409ZU/P416ZU & CONNECT/TERMINATE.
- 7 - LV CABLING SHALL BE RUN BELOW (DEEPER THAN STANDARD ELECTRICAL TRENCH DEPTH/COVER) SEWER/DRAINAGE WITH A MINIMUM OF 300mm CLEARANCE AT CROSSOVER LOCATIONS. COORDINATE ON SITE WITH CIVIL CONTRACTOR.
- 8 - MINIMUM 300mm HORIZONTAL SEPARATION REQUIRED BETWEEN EDGE OF NBN CONDUIT/S & DIRECT BURIED LV CABLING. WHERE 300mm SEPARATION NOT PROVIDED, LV CABLING SHALL BE INSTALLED IN 100mm HD UPVC CONDUIT. ALSO REFER DWG No. B23-7109, DETAILS B & C.

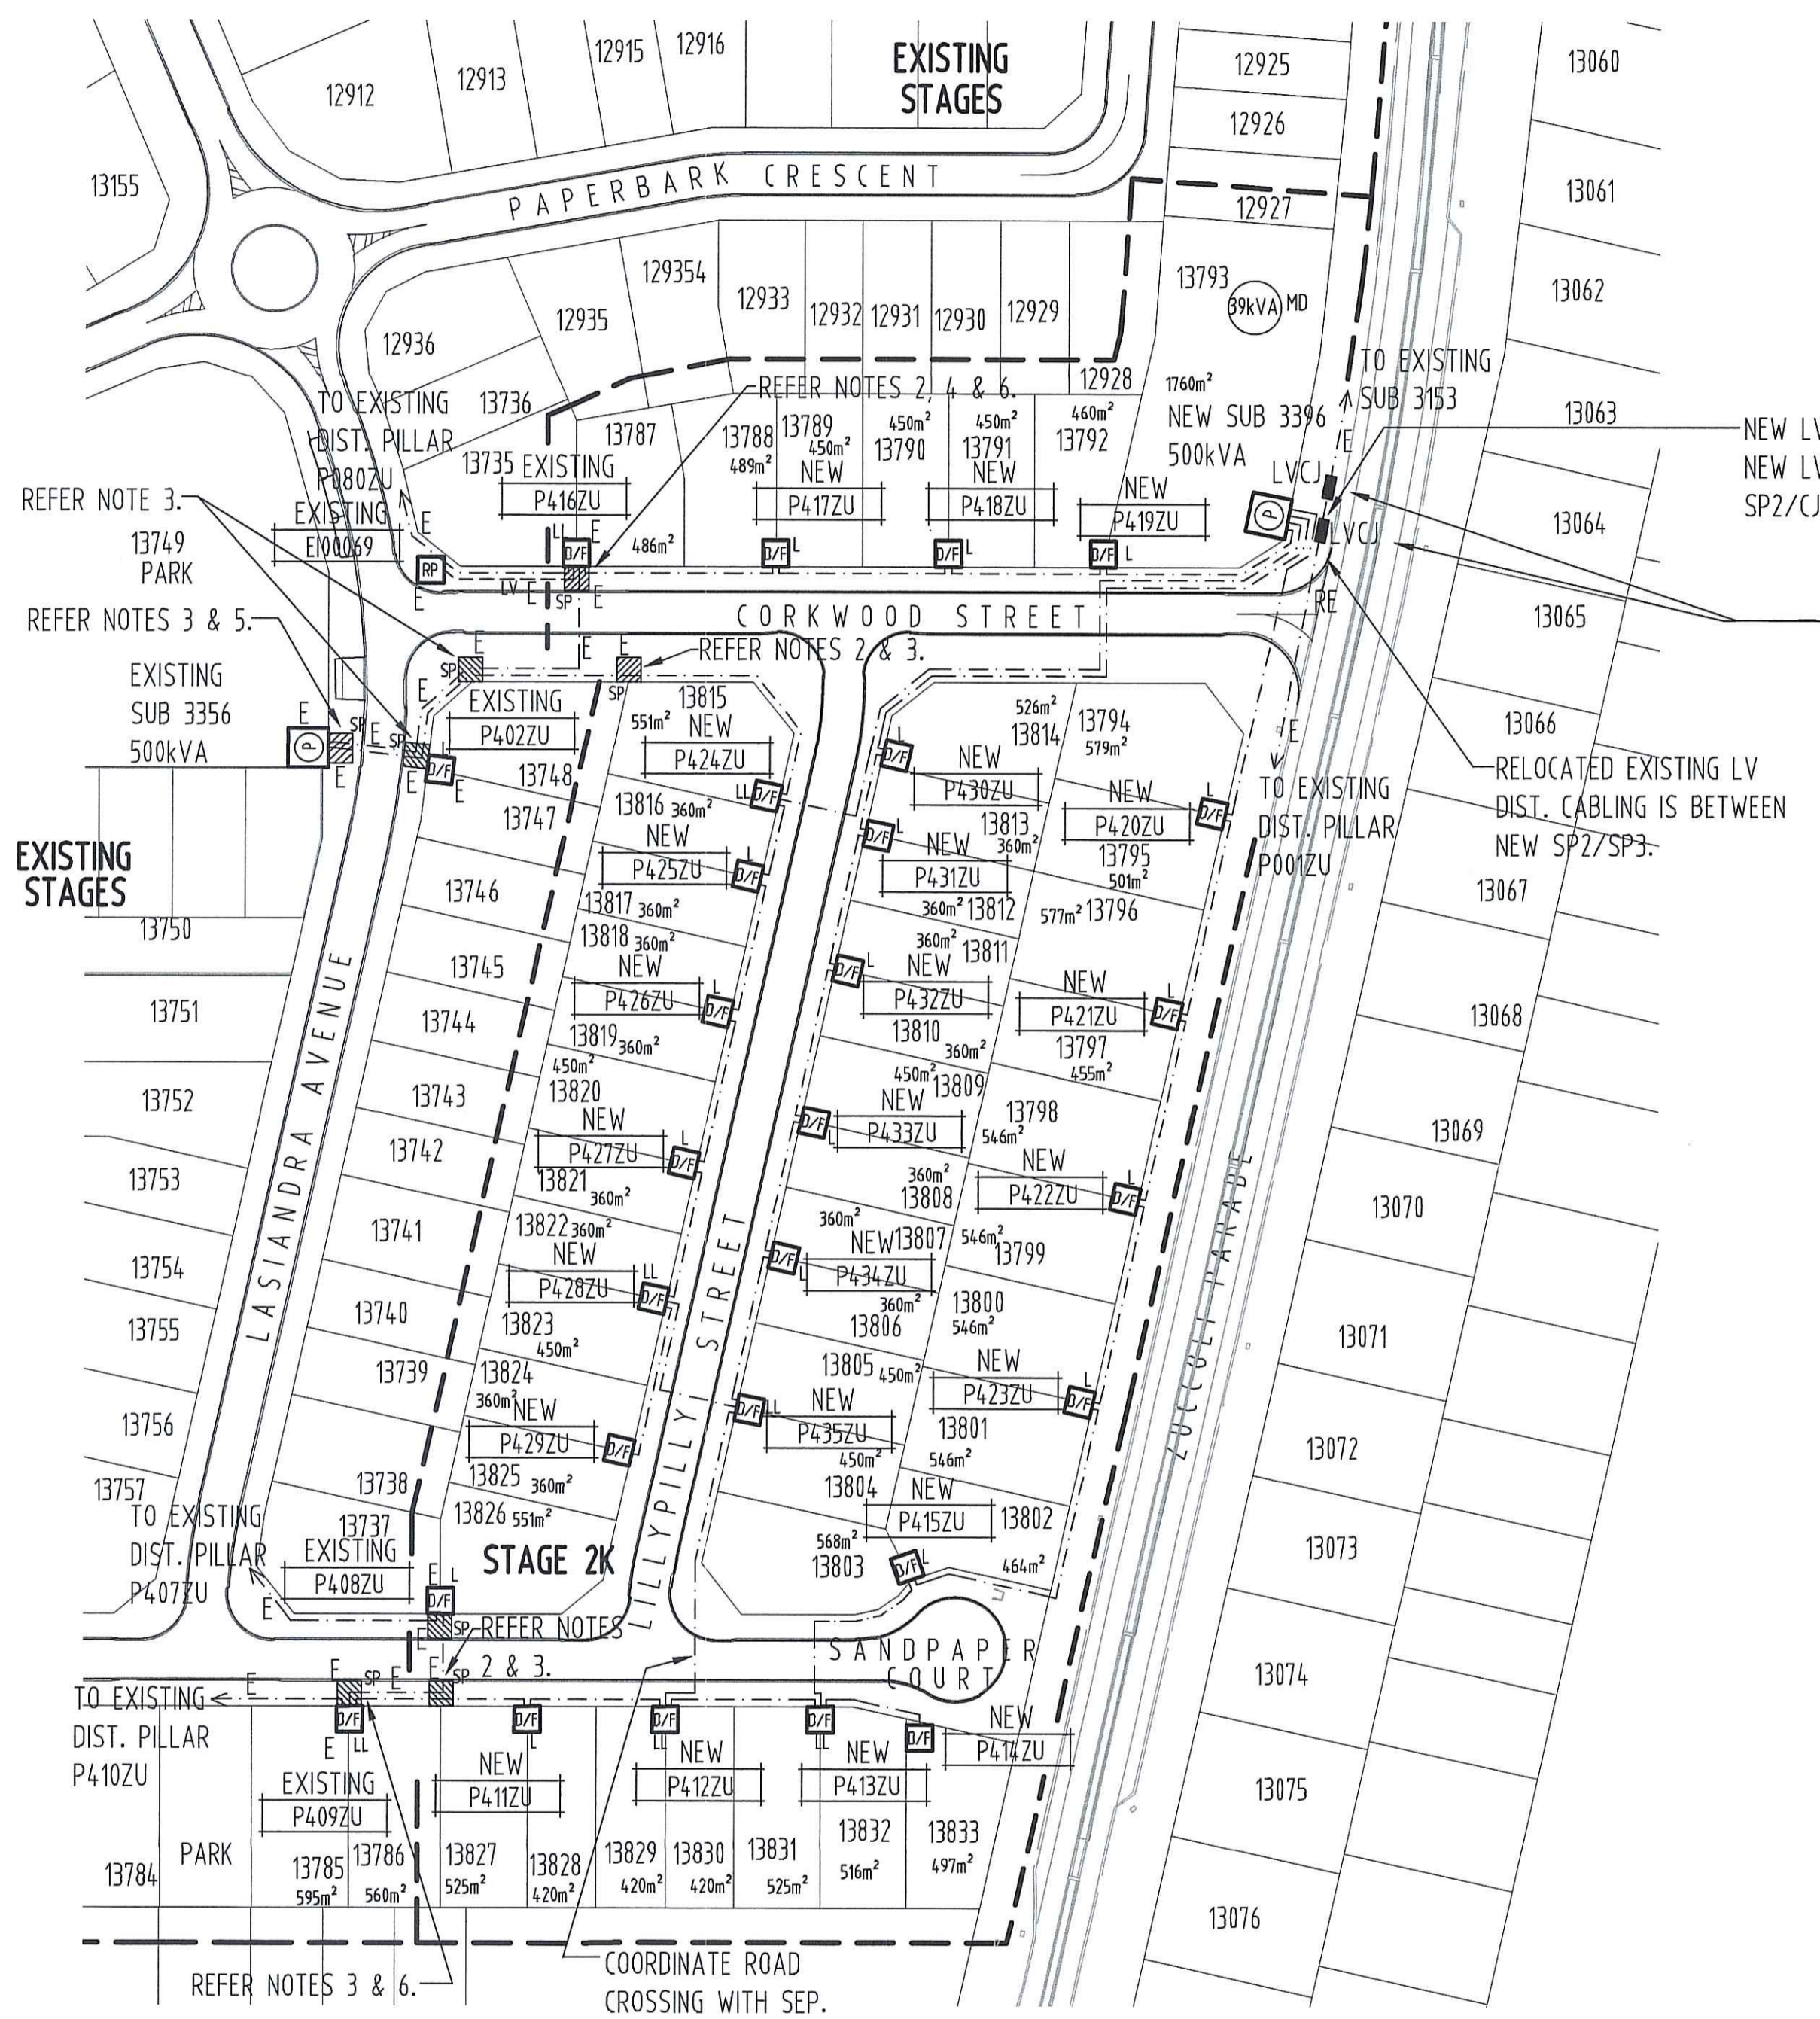

TO EXISTING SUB 3153  
NEW LV DIST. CABLING BETWEEN 2  
NEW LV CABLE JOINTS (IN NEW SP2/CJSP).

CONTRACTOR SHALL ARRANGE FOR POWER AND WATER TO LOCATE EXISTING LV DIST. CABLING (BETWEEN EXISTING SUB 3153/EXISTING DIST. PILLAR P001ZU) IN LOCATIONS SHOWN/CONTRACTOR SHALL EXCAVATE & EXPOSE EXISTING CONDUITS. POWER AND WATER TO CUT EXISTING LV DIST. CABLING IN NEW CJSP, PULL BACK END FROM EXISTING DIST. PILLAR P001ZU TO NEW SP3, THEN PULL BACK THROUGH NEW 1x100mm HD UPVC CONDUIT AT NEW ROAD CROSSING TO NEW SP2, SUPPLY/INSTALL NEW LV DIST. CABLING BETWEEN NEW SP2/CJSP IN EXISTING 1x100mm HD UPVC CONDUIT VACATED ONCE EXISTING LV DIST. CABLING REMOVED & JOINT NEW LV DIST. CABLING TO EXISTING IN NEW CJSP & IN NEW SP2.

RELOCATED EXISTING LV DIST. CABLING IS BETWEEN NEW SP2/SP3.

**POWER AND WATER INSTRUCTIONS TO DEVELOPER**

The Developer shall ensure that any Contractor employed to carry out work on this electrical reticulation is accredited by Power and Water for the particular work.

The Contractor shall only carry out work in accordance with the approved drawings and the "Design and Construction of Network Assets" requirements.

**POWER AND WATER**

This drawing has been endorsed in principal for electrical construction in respect of:

- High Voltage calculation details
- Low Voltage reticulation details
- Substation reticulation details
- Substation / Switchgear details

This endorsement is based on the Consultant certifying that the design complies with Power and Water's requirements, the accuracy of the information and data provided has been checked on file and the design details. The endorsement is not intended to be construed that Power and Water accepts responsibility for the individual accuracy of the design. This responsibility remains absolute with the Developer's electrical consultant.

This endorsement is valid for 12 months from the date of issue. Should this period be exceeded prior to commencement of work or any significant change have been made, drawings must be re-submitted for endorsement in accordance with current standards.

Endorsement is subject to the conditions listed below.

Signed: Date: 29 Sep 23

PILLAR SCHEDULE			
PILLAR	630A STRIPPLE FUSE UNIT	160A STRIPPLE FUSE UNIT	No. OF SLOTS
P411ZU	2	1	3
P412ZU	3	1	5
P413ZU	3	1	5
P414ZU	1	1	3
P415ZU	2	1	3
P417ZU	2	1	3
P418ZU	2	1	3
P419ZU	2	2	3
P420ZU	2	1	3
P421ZU	2	1	3
P422ZU	2	1	3
P423ZU	2	1	3
P424ZU	3	1	5
P425ZU	2	1	3
P426ZU	2	1	3
P427ZU	2	1	3
P428ZU	3	1	5
P429ZU	1	1	3
P430ZU	2	1	3
P431ZU	2	1	3
P432ZU	2	1	3
P433ZU	2	1	3
P434ZU	2	1	3
P435ZU	3	1	5

**SITE PLAN** (1:1000 AT A1)

<p>DEVELOPER: <b>TERRITORY LIFE</b> GPO Box 1779 DARWIN NT 0801</p> <p>PHONE: 0417 160700 FACSIMILE: EMAIL: clement.williams@territorylife.com.au CONTACT: CLEMENT WILLIAMS</p>	<p> <b>AGA CONSULTING ENGINEERS PTY LTD</b> ELECTRICAL &amp; MECHANICAL ACN 070 262 296</p> <p>GPO BOX 3097 DARWIN NT 0801</p> <p>TELEPHONE: 08 89465582 FACSIMILE: 08 89421400 EMAIL: ciek@agoeeng.com.au</p>	<table border="1" style="width: 100%; border-collapse: collapse;"> <tr> <th>NO</th> <th>DESCRIPTION</th> <th>DRN</th> <th>DATE</th> <th>APPD</th> <th>DRG NO</th> <th>TITLE</th> </tr> <tr> <td>E</td> <td>RE-ISSUED FOR POWER AND WATER APPROVAL</td> <td>K.T.</td> <td>25-9-23</td> <td>A.G.</td> <td>B23-7114</td> <td>SINGLE LINE DIAGRAM &amp; LEGEND</td> </tr> <tr> <td>D</td> <td>RE-ISSUED FOR POWER AND WATER APPROVAL</td> <td>K.T.</td> <td>15-9-23</td> <td>A.G.</td> <td>B23-7113</td> <td>NOTES, SCHEDULES &amp; HV SCHEMATICS</td> </tr> <tr> <td>C</td> <td>LAYOUT, LEGEND, NOTES &amp; SCHEDULES AMENDED</td> <td>K.T.</td> <td>29-4-23</td> <td>A.G.</td> <td>B23-7112</td> <td>MASTER SERVICES PLAN</td> </tr> <tr> <td>B</td> <td>ISSUED FOR POWER AND WATER APPROVAL</td> <td>K.T.</td> <td>2-6-23</td> <td>A.G.</td> <td>B23-7111</td> <td>CONDUIT/DUCT LAYOUT</td> </tr> <tr> <td>A</td> <td>ISSUED FOR POWER AND WATER REVIEW</td> <td>K.T.</td> <td>9-5-23</td> <td>A.G.</td> <td>B23-7109</td> <td>HV ELECTRICAL RETICULATION</td> </tr> </table>	NO	DESCRIPTION	DRN	DATE	APPD	DRG NO	TITLE	E	RE-ISSUED FOR POWER AND WATER APPROVAL	K.T.	25-9-23	A.G.	B23-7114	SINGLE LINE DIAGRAM & LEGEND	D	RE-ISSUED FOR POWER AND WATER APPROVAL	K.T.	15-9-23	A.G.	B23-7113	NOTES, SCHEDULES & HV SCHEMATICS	C	LAYOUT, LEGEND, NOTES & SCHEDULES AMENDED	K.T.	29-4-23	A.G.	B23-7112	MASTER SERVICES PLAN	B	ISSUED FOR POWER AND WATER APPROVAL	K.T.	2-6-23	A.G.	B23-7111	CONDUIT/DUCT LAYOUT	A	ISSUED FOR POWER AND WATER REVIEW	K.T.	9-5-23	A.G.	B23-7109	HV ELECTRICAL RETICULATION	<table border="1" style="width: 100%; border-collapse: collapse;"> <tr> <th colspan="2">DRAWING STATUS</th> <th>APPD</th> <th>DATE</th> </tr> <tr> <td>P</td> <td>PRELIMINARY/PROPOSED</td> <td></td> <td></td> </tr> <tr> <td>T</td> <td>TENDERING PURPOSES ONLY</td> <td></td> <td></td> </tr> <tr> <td>AC</td> <td>APP. FOR CONSTRUCTION</td> <td></td> <td></td> </tr> <tr> <td>AI</td> <td>AS INSTALLED</td> <td></td> <td></td> </tr> <tr> <td>C</td> <td>CANCELLED/SUPERSEDED</td> <td></td> <td></td> </tr> </table> <p>ASSOCIATED DRAWINGS AGA406-18A</p>	DRAWING STATUS		APPD	DATE	P	PRELIMINARY/PROPOSED			T	TENDERING PURPOSES ONLY			AC	APP. FOR CONSTRUCTION			AI	AS INSTALLED			C	CANCELLED/SUPERSEDED			<p style="text-align: center;"><b>PowerWater</b> NORTHERN TERRITORY</p>	<table border="1" style="width: 100%; border-collapse: collapse;"> <tr> <td>DES</td> <td>A.GANGUR</td> <td rowspan="3" style="text-align: center;"><b>POWER SERVICES - PALMERSTON DISTRIBUTION</b></td> </tr> <tr> <td>DRN</td> <td>K.TAVENER</td> </tr> <tr> <td>CKD</td> <td>A.GANGUR</td> </tr> <tr> <td>APPD</td> <td></td> <td style="text-align: center;"><b>SUBDIVISION OF LOT 12087</b></td> </tr> <tr> <td>SCALE</td> <td>AS SHOWN</td> <td style="text-align: center;"><b>ZUCCOLI SUBDIVISION - STAGE 2 : STAGE 2K</b></td> </tr> <tr> <td>ISSUED</td> <td>25-9-23</td> <td style="text-align: center;"><b>LV ELECTRICAL RETICULATION</b></td> </tr> <tr> <td>ALL DIM.</td> <td>IN mm</td> <td style="text-align: center;"><b>STAGE 2K</b></td> </tr> <tr> <td>DRAFTING STANDARD</td> <td>TO A.S.1100</td> <td style="text-align: center;"><b>LV ELECTRICAL RETICULATION</b></td> </tr> </table> <p style="text-align: center;">DRAWING NUMBER <b>B23-7110</b></p> <p style="text-align: center;">FILE No: NE590/12087</p>	DES	A.GANGUR	<b>POWER SERVICES - PALMERSTON DISTRIBUTION</b>	DRN	K.TAVENER	CKD	A.GANGUR	APPD		<b>SUBDIVISION OF LOT 12087</b>	SCALE	AS SHOWN	<b>ZUCCOLI SUBDIVISION - STAGE 2 : STAGE 2K</b>	ISSUED	25-9-23	<b>LV ELECTRICAL RETICULATION</b>	ALL DIM.	IN mm	<b>STAGE 2K</b>	DRAFTING STANDARD	TO A.S.1100	<b>LV ELECTRICAL RETICULATION</b>
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**WARNING**

BEWARE OF EXISTING UNDERGROUND SERVICES.  
CONTRACTOR SHALL CONFIRM LOCATIONS OF SERVICES  
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**GIFTED ASSETS**

**NOTES**

1 - REFER DWG No. B23-7113 FOR DETAILS OF ITEMS LISTED  
IN LEGEND (EXCLUDING WATER/SEWER/DRAINAGE  
CONNECTION).

**LEGEND**


- NEW PACKAGE SUBSTATION (RATING AS SHOWN).  
'E' INDICATES EXISTING.
- NEW DISTRIBUTION DOUBLE LINK PILLAR - FUSED TYPE.  
'E' INDICATES EXISTING.
- NEW DISTRIBUTION LINK PILLAR - FUSED TYPE.  
'E' INDICATES EXISTING.
- EXISTING DISTRIBUTION PILLAR - FUSED TYPE.  
'E' INDICATES EXISTING.
- NEW WATER CONNECTION.  
'E' INDICATES EXISTING.
- NEW SEWER CONNECTION.  
'E' INDICATES EXISTING.
- NEW DRAINAGE CONNECTION.

**POWER AND WATER  
INSTRUCTIONS TO DEVELOPER**

The Developer shall ensure that any Contractor employed to  
carry out work on this electrical reticulation is accredited by  
Power and Water for the particular work.  
  
The Contractor shall only carry out work in accordance with  
the approved drawings and the "Design and Construction of  
Network Assets" requirements.



**SITE PLAN** (1:1000 AT A1)

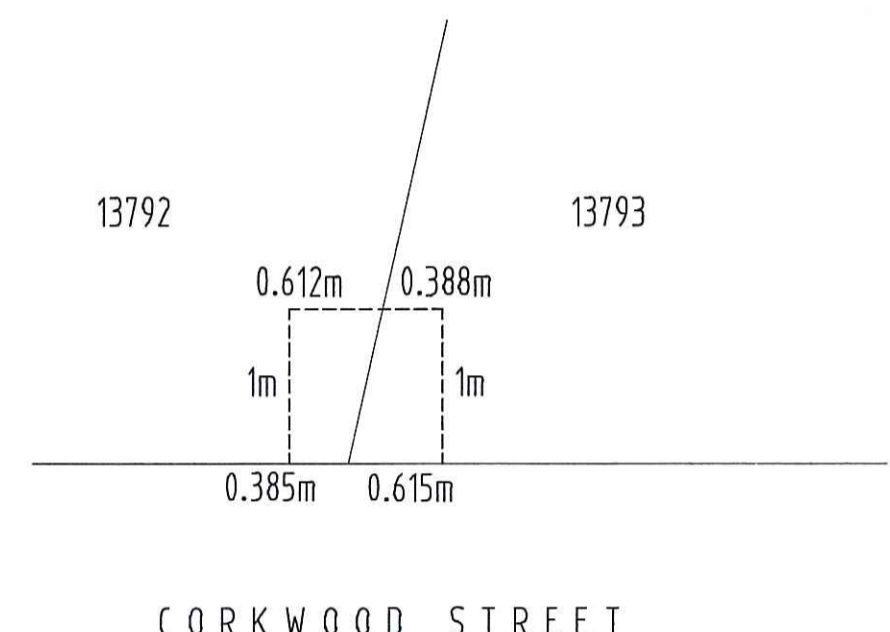

**DETAIL F - ELEC EASEMENT PILLAR P419ZU IN LOTS 13792/13793** (1:5 AT A1)


**POWER AND WATER**  
This drawing has been endorsed in principle for electrical construction in respect of:

- High Voltage reticulation details
- Low Voltage reticulation details
- Straightline reticulation details
- Cable duct details
- Substation/Storage details


This endorsement is intended for the Consultant certifying that the design complies with  
Power and Water requirements. The accuracy of the design and the reticulation services  
have been checked. It is the responsibility of the design engineer to ensure that the design  
complies with the relevant standards and the design is suitable for the intended use of the  
design. This responsibility is not transferred to the Consultant. Should this  
period be exceeded, the design must be re-submitted for endorsement in accordance with current  
standards.  
Endorsement is subject to the conditions listed below.

Signed: [Signature] Date: 29 Sep 23  
Network Engineering

**DETAIL G - ELEC EASEMENT PILLAR P415ZU IN LOTS 13802/13803** (1:5 AT A1)

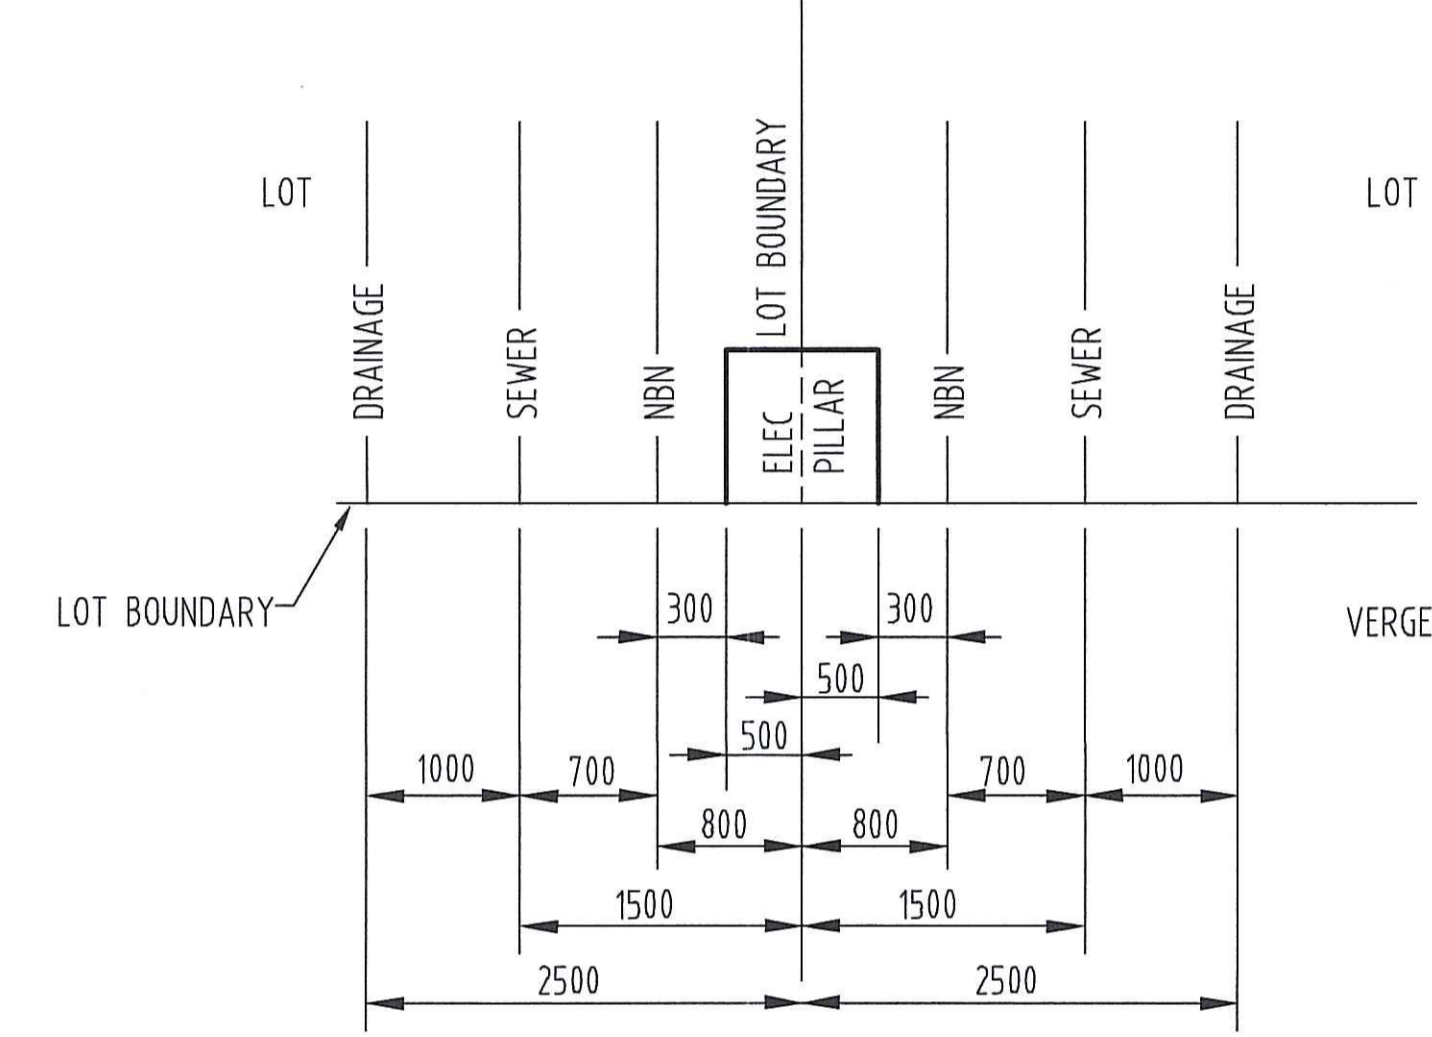

**DETAIL D - TYPICAL OFFSETS FOR ELEC/NBN/SEWER/DRAINAGE/WATER  
LOT CONNECTIONS - ELEC PILLAR IN 2 LOTS** (N.T.S.)

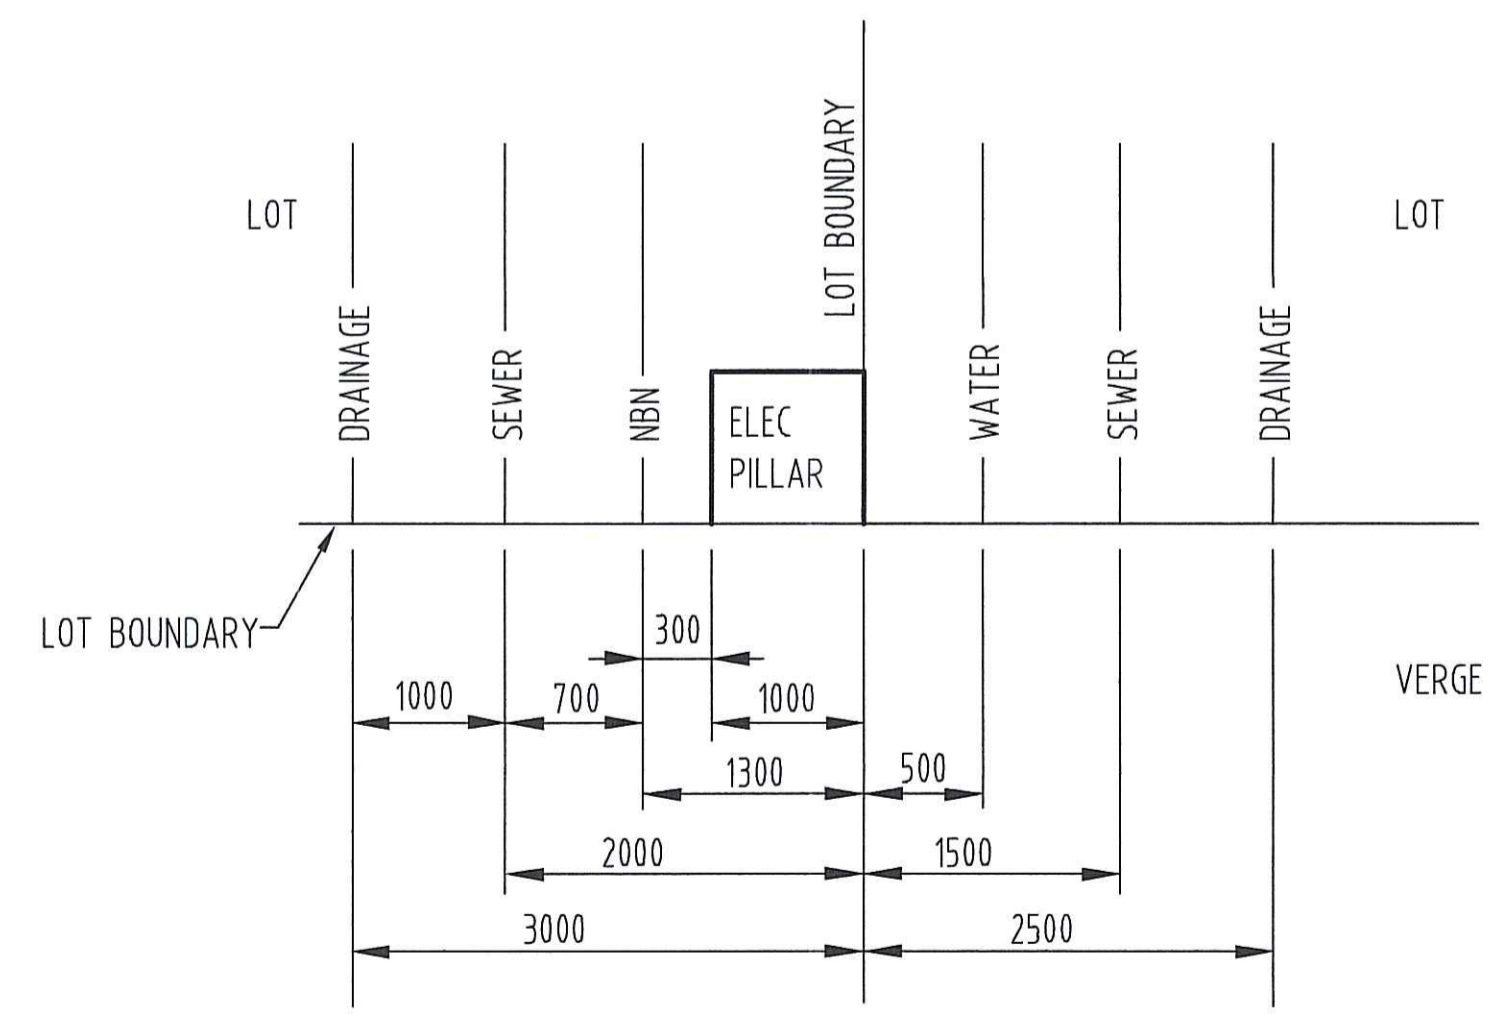

**DETAIL E - TYPICAL OFFSETS FOR ELEC/NBN/SEWER/DRAINAGE/WATER  
LOT CONNECTIONS - ELEC PILLAR IN 1 LOT** (N.T.S.)

DEVELOPER: <b>TERRITORY LIFE</b> GPO Box 1779 DARWIN NT 0801		AGA CONSULTING ENGINEERS PTY LTD ELECTRICAL & MECHANICAL ACN 070 242 296	D C B A	RE-ISSUED FOR POWER AND WATER APPROVAL LAYOUT & LEGEND AMENDED ISSUED FOR POWER AND WATER APPROVAL ISSUED FOR POWER AND WATER REVIEW	K.T. K.T. K.T.	15-9-23 29-4-23 9-5-23	A.G. A.G. A.G.	B23-7114 B23-7113 B23-7111 B23-7110 B23-7109	SINGLE LINE DIAGRAM & LEGEND NOTES, SCHEDULES & HV SCHEMATICS CONDUIT/DUCT LAYOUT LV ELECTRICAL RETICULATION HV ELECTRICAL RETICULATION	DRAWING STATUS		APPD	DATE	DES DRN CKD APPD	A.GANGUR K.TAVENER A.GANGUR	POWER SERVICES - PALMERSTON DISTRIBUTION SUBDIVISION OF LOT 12087 ZUCCOLI SUBDIVISION - STAGE 2 : STAGE 2K MASTER SERVICES PLAN				
										P T AC AI C	PRELIMINARY/PROPOSED TENDERING PURPOSES ONLY APP. FOR CONSTRUCTION AS INSTALLED CANCELLED/SUPERSEDED									
PHONE: 0417 160700 FACSIMILE: EMAIL: clement.williams@territorylife.com.au CONTACT: CLEMENT WILLIAMS	GPO BOX 3097 DARWIN NT 0801	TELEPHONE: 08 89416582 FACSIMILE: 08 89427400 EMAIL: dlekg@agang.com.au	NO	DESCRIPTION	DRN	DATE	APPD	DRG NO	TITLE	ASSOCIATED DRAWINGS	AGA406-18A			SCALE AS SHOWN	ISSUED 15-9-23	ALL DIM. IN mm	DRAFTING STANDARD TO A.S.1100	FILE No: NE590/12087	DRAWING NUMBER <b>B23-7112</b>	



AGANGUR  
K.TAVENER  
A.GANGUR  
AS SHOWN  
15-9-23  
IN mm  
A.S.1100  
NE590/12087  
**B23-7112**  
AMDT

**GIFTED ASSETS**

**NOTES - WORKS BY DEVELOPERS CONTRACTOR**

1 - ALL WORKS SHALL BE CARRIED OUT IN ACCORDANCE WITH CURRENT POWER AND WATER CONSTRUCTION METHODS, REQUIREMENTS & STANDARDS AS DETAILED IN POWER AND WATER DESIGN AND CONSTRUCTION GUIDELINES, UNDERGROUND MANUAL & ACCESS TO APPARATUS RULES.

2 - ALL PURCHASED MATERIALS/EQUIPMENT TO CONSTRUCT ELECTRICAL RETICULATION SHALL BE IN ACCORDANCE WITH POWER AND WATER'S RELEVANT STANDARDS/TECHNICAL REQUIREMENTS AND FROM A POWER AND WATER AUTHORISED MANUFACTURER, SPECIFICALLY FOR HIGH VOLTAGE AND LOW VOLTAGE DISTRIBUTION NETWORKS. ANY NON-STANDARD MATERIALS/EQUIPMENT USED WITHOUT OBTAINING PRIOR APPROVAL IN WRITING FROM POWER NETWORKS, ASSET MANAGEMENT QUALITY GROUP CAN BE REJECTED AND REPLACED BY THE APPROVED STANDARD ITEM BEFORE POWER AND WATER ACCEPTS THE HANDOVER OF ELECTRICAL ASSETS AND ISSUING POWER CLEARANCE FOR THE CONSTRUCTION/DEVELOPMENT. IF UNSURE, CONTACT POWER AND WATER POWER NETWORK ASSET MANAGEMENT QUALITY GROUP ON [standardsengineers@powerwater.com.au](mailto:standardsengineers@powerwater.com.au).

3 - IN COMPLIANCE TO SAFETY REQUIREMENTS REGARDING ACCESS TO APPARATUS RULES, ALL OPENINGS OR TRENCHES IN FRONT OF APPLICABLE POWER ASSETS WHICH ARE CURRENTLY IN SERVICE MUST BE BACKFILLED OR HAVE SUBSTANTIAL COVER (SUITABLE STEEL PLATE OR 19mm FORM PLY SECURED TO A 150mm x 100mm TIMBER CROSS MEMBERS) OVER THE OPENINGS WHEN WORKS HAVE COMPLETED FOR THE DAY IN ORDER TO ALLOW POWER AND WATER'S PERSONNEL SAFE ACCESS TO THE APPARATUS & TO PERFORM ANY SWITCHING IF REQUIRED, IN ADDITION TO CURRENT STANDARD FENCING ARRANGEMENT.

4 - CONTRACTOR SHALL CONTACT & SUBMIT AN UNDERGROUND INSTALLATION PROGRAMME TO POWER AND WATER DEMAND AND DEVELOPMENT SERVICES (DDS) VIA E-MAIL ([connection.pwc@powerwater.com.au](mailto:connection.pwc@powerwater.com.au)) THIRTY (30) DAYS PRIOR TO COMMENCEMENT OF CONSTRUCTION WORKS. THE UNDERGROUND INSTALLATION PROGRAMME SHALL BE AGREED BY DDS 7 DAYS PRIOR TO WORK COMMENCING.

**ANTICIPATED CONSTRUCTION COMMENCEMENT NOVEMBER 2023.**

5 - SUBSTATION SHALL BE SUPPLIED BY CONTRACTOR AND SHALL BE MK3 (500kVA, 11kV/433V) TYPE IN ACCORDANCE WITH POWER AND WATER STANDARD DWG'S S02-01-07-18\_1, S02-01-07-018\_2, S02-01-07-18\_3 & S02-01-07-18\_4. SUBSTATION SHALL BE INSTALLED BY CONTRACTOR IN ACCORDANCE WITH POWER AND WATER STANDARD DWG'S S02-02-05-10, S02-02-06-33, S02-02-06-37\_1, S02-02-06-37\_2, S02-02-06-37\_3, S02-02-06-37\_4, S02-02-06-40 & S02-02-06-41. "ARMCO" SAFETY BARRIERS ARE NOT REQUIRED. CONTRACTOR SHALL DELIVER/PICK UP TO/FROM POWER AND WATER BEN HAMMOND WORKSHOP & ARRANGE FOR POWER AND WATER TO TEST NEW SUBSTATION/HV SWITCHGEAR & SUPPLY/INSTALL NEW SIM CARD FOR TARRIF METER FOR NEW SUBSTATION. CONTACT IS "TEST & PROTECTION" TELEPHONE No. 8985 7186. SUBSTATION SHALL BE POWDER COATED TO AS 3715 COLOR - 'HERITAGE GREEN'.

6 - FUSED DISTRIBUTION PILLARS SHALL BE SUPPLIED AND INSTALLED BY CONTRACTOR AND LABELLED IN ACCORDANCE WITH POWER AND WATER REQUIREMENTS. LABELS SHALL BE PROVIDED BY CONTRACTOR. PILLARS SHALL BE TYPE IN ACCORDANCE WITH POWER AND WATER STANDARD DWG S02-02-03-08 & INSTALLATION IN ACCORDANCE WITH POWER AND WATER STD DWG'S S02-02-03-12 & S02-02-03-13.

7 - SERVICE ALLOCATIONS SHALL BE AS PER DWG No. B23-7109, DETAIL A AND SHALL BE INSTALLED IN ACCORDANCE WITH POWER AND WATER STANDARD DWG'S S02-02-06-02 AND S02-02-06-03 (TRENCH DETAILS). ALSO REFER DWG No. B23-7109, DETAILS B & C AND DWG No. B23-7111, DETAIL H.

8 - ELECTRICITY EASEMENTS SHALL BE IN ACCORDANCE WITH POWER AND WATER STANDARD DWG'S S02-02-06-17.  
- SUBSTATION : 4mx3.5m  
- FUSED PILLARS: 1mx1m WHERE PILLAR FULLY IN 1 LOT OR 0.5mx1m WHERE HALF PILLAR IN 1 LOT (IE ON COMMON BOUNDARY) FOR 3 & 5 SLOT FUSED PILLAR.  
WHERE FRONT/SIDE OF PILLARS ELECTRICITY EASEMENTS DO NOT ALIGN WITH FRONT OF SIDE LOT BOUNDARIES, ELECTRICITY EASEMENTS SHALL EXTEND TO FRONT OR SIDE LOT BOUNDARY. DEVELOPER SHALL SURVEY & REGISTER ELECTRICITY EASEMENTS REQUIRED IN FAVOUR OF POWER AND WATER (AT NO COST TO POWER AND WATER).

9 - LV CABLES SUPPLIED AND INSTALLED BY CONTRACTOR SHALL BE TYPE IN ACCORDANCE WITH POWER AND WATER STANDARD DWG'S S02-01-01-19 AND S02-01-01-20. HV CABLES SUPPLIED & INSTALLED BY CONTRACTOR SHALL BE TYPE IN ACCORDANCE WITH POWER AND WATER STANDARD DWG S02-01-01-25.

10 - SERVICE CABLES FROM DIST. PILLARS TO WITHIN EACH LOT IS TO BE PROVIDED BY LOT OWNER.

11 - CONTRACTOR SHALL LIAISE WITH NBN CONTRACTOR TO ENABLE CONDUITS AND COMMUNICATIONS PITS TO BE INSTALLED BY NBN CONTRACTOR AT THE APPROPRIATE CONSTRUCTION STAGE (INCLUDING CONDUITS AT ROAD CROSSINGS). THE CONTRACTOR SHALL BACKFILL/COMPACT TRENCHES, UPON INSTALLATION OF ELECTRICAL SERVICES CABLING, TO A LEVEL IN ACCORDANCE WITH STANDARD POWER AND WATER DWG'S S02-02-06-02 TO ENABLE NBN CONTRACTOR TO INSTALL COMMUNICATIONS CONDUITS AND PITS. THE CONTRACTOR SHALL THEN COMPLETE BACKFILL/COMPACTION OF TRENCHES.

12 - CONTRACTOR SHALL INSTALL ALL NUMBER PLATES (LABELS) REQUIRED BY POWER AND WATER IE SUBSTATION & PILLARS. NOTE - SUBSTATION NUMBER PLATES & HV SWITCHES NUMBER PLATES WILL BE PROVIDED BY POWER AND WATER TO CONTRACTOR. CONTRACTOR SHALL LABEL ALL CABLE DESTINATIONS IN ACCORDANCE WITH POWER AND WATER STANDARD DRAWING S02-01-08-25.

13 - ALL WORKS REQUIRED ON EXISTING ENERGISED RETICULATION SHALL ONLY BE CARRIED OUT BY POWER AND WATER PERSONNEL. DEVELOPER/CONTRACTOR SHALL LIAISE WITH POWER AND WATER TO COORDINATE CONNECTION OF THE WORK INTO EXISTING UNDERGROUND RETICULATION. ALL COSTS ASSOCIATED SHALL BE PAID BY DEVELOPER.

14 - DEVELOPER SHALL ENSURE THAT ONLY POWER AND WATER ACREDITED ELECTRICAL CONTRACTOR IS EMPLOYED TO CARRY OUT WORK ON THIS ELECTRICAL SYSTEM (CONTACT MANAGER NETWORK ENGINEERING - 8924 5191).

15 - DEVELOPER SHALL LIAISE WITH POWER AND WATER TO OBTAIN "HANDOVER OF WORK BY DEVELOPER". CONTRACTOR SHALL SUBMIT TO POWER AND WATER ON COMPLETION OF WORK, SIGNED COPY OF "CONTRACTOR'S CERTIFICATE OF COMPLETION & HANDOVER - POWER NETWORK ASSETS" & SIGNED COPY OF "ELECTRICAL CERTIFICATE OF COMPLIANCE".

16 - CABLE ROUTE LENGTHS NOMINATED ON SINGLE LINE DIAGRAM ARE FOR POWER AND WATER INFORMATION ONLY & SHALL NOT BE USED FOR TENDERING PURPOSES.

17 - COORDINATE WITH CIVIL SERVICES FOR LOCATION OF WATER, SEWERAGE AND DRAINAGE SERVICES.

18 - CONTRACTOR SHALL PROVIDE "AS CONSTRUCTED" DRAWINGS IN ACCORDANCE WITH POWER AND WATER'S "POWER NETWORKS DESIGN AND CONSTRUCTION GUIDELINES", INCLUDING A COPY OF THE FINAL SURVEY PLAN. THE "AS CONSTRUCTED" DRAWINGS SHALL INCLUDE:

- 1 x A1 PAPER PRINT INDICATING "AS INSTALLED" (OF ALL DRAWINGS).
- 1 x A3 PAPER PRINT INDICATING "AS INSTALLED" (OF ALL DRAWINGS).
- 1 DIGITAL (USB) COPY OF ALL DRAWINGS (MICROSTATION .DGN FILES).

**NOTES - WORKS BY POWER AND WATER (AT DEVELOPERS COST)**

1 - CONTRACTOR SHALL ARRANGE FOR POWER AND WATER TO CARRY OUT THE FOLLOWING WORKS:

- CUT EXISTING HV CABLE (BETWEEN EXISTING RMU-2 HV SW12445 AND RMU-3 HV SW12446 - EXPOSED BY CONTRACTOR) IN NEW CJSP, PULL BACK ONE END (FROM EXISTING RMU-3 HV SW12446) TO NEW SP3 AND THEN PULL INTO NEW SUB 3396 HV SECTION (VIA NEW 1x150mm HD uPVC CONDUIT AT ROAD CROSSING BETWEEN NEW SP2/SP3 AND NEW 3x100mm HD uPVC CONDUITS BETWEEN NEW SP2 AND NEW SUB 3396) & CONNECT/TERMINATE TO HV SW21887, JOINT OTHER END (FROM EXISTING RMU-2 HV SW12445) TO NEW HV CABLE (FROM NEW SUB 3396 HV SW21888) LEFT COILED IN NEW SAND PIT SP2 BY CONTRACTOR, POWER AND WATER TO EXTEND TO NEW CJSP VIA EXISTING VACATED 1x150mm HD uPVC CONDUIT.
- CUT EXISTING LV DIST. CABLING (BETWEEN EXISTING SUB 3153 AND EXISTING DIST. PILLAR P001ZU - EXPOSED BY CONTRACTOR) IN NEW CJSP, PULL BACK END FROM EXISTING DIST. PILLAR P001ZU TO NEW SP3, THEN PULL BACK THROUGH NEW 1x100mm HD uPVC CONDUIT AT ROAD CROSSING BETWEEN NEW SP2/SP3 TO NEW SP2, SUPPLY/INSTALL NEW LV DIST. CABLING IN EXISTING VACATED 1x100mm HD uPVC CONDUIT BETWEEN NEW CJSP/SP2 & JOINT TO NEW LV DIST. CABLING TO EXISTING IN NEW CJSP & NEW SP2.
- PULL THROUGH NEW LV DIST. CABLING (FROM NEW DIST. PILLAR P424ZU) LEFT COILED IN EXISTING SAND PIT IN FRONT OF EXISTING SUB 3356 & CONNECT/TERMINATE TO EXISTING SUB 3356 SPARE LV STRIPPLE FUSE UNIT.
- PULL THROUGH NEW LV DIST. CABLING (FROM NEW DIST. PILLAR P417ZU) LEFT COILED IN EXISTING SAND PIT IN FRONT OF EXISTING DIST. PILLAR P416ZU & CONNECT/TERMINATE TO EXISTING DIST. PILLAR P416ZU.
- PULL THROUGH NEW LV DIST. CABLING (FROM NEW DIST. PILLAR P411ZU) LEFT COILED IN FRONT OF EXISTING DIST. PILLAR P409ZU & CONNECT/TERMINATE TO EXISTING DIST. PILLAR P409ZU.
- CARRY OUT EARTH TESTS.
- COMPLETE FINAL CONNECTION, TESTING & COMMISSIONING OF NEW SUB 3396, DISTRIBUTION PILLARS & ASSOCIATED CABLING/WORKS.

2 - DEVELOPER SHALL PAY ALL ASSOCIATED COSTS FOR POWER AND WATER TO CARRY OUT ABOVE WORKS. POWER AND WATER'S FINAL CONNECTION QUOTE FOR PAYMENT SHALL ONLY BE PROVIDED TO THE DEVELOPER OR THE DEVELOPER'S SUCCESSFUL ELECTRICAL CONTRACTOR WITH A WRITTEN ADVICE BY THE DEVELOPER.

LV ASSET SCHEDULE		
DESCRIPTION	LOCATION ID	STOCK CODE
DISTRIBUTION PILLAR (3-SLOTS)	REFER TO PILLAR SCHEDULE	292326
DISTRIBUTION PILLAR (5-SLOTS)	REFER TO PILLAR SCHEDULE	292334
LV DISTRIBUTION CABLE SINGLE CORE 0.6/1kV 240 Sq mm AI, XLPE/PVC/MDPE		401015

HV ASSET SCHEDULE				
DESCRIPTION	LOCATION	STOCK CODE	SERIAL NUMBER	TEST NUMBER
SUB 3396 MK3 500kVA 3-WAY	ZUCCOLI PARADE ZUCCOLI	503369	TBA	TBA
11kV 1C 400 Sq mm AI/XLPE CABLE	ZUCCOLI PARADE ZUCCOLI	286039	N/A	N/A

**POWER AND WATER INSTRUCTIONS TO DEVELOPER**

The Developer shall ensure that any Contractor employed to carry out work on this electrical reticulation is accredited by Power and Water for the particular work.

The Contractor shall only carry out work in accordance with the approved drawings and the "Design and Construction of Network Assets" requirements.

**POWER AND WATER**

This drawing has been endorsed in principle for electrical construction in respect of:


- High Voltage reticulation design
- LV electrical reticulation design
- Cable selection
- Substation / Spare meter details

This endorsement is issued at the Consultant certifying that the design complies with Power and Water's requirements. It is the responsibility of the Contractor and electrical services have been checked for compliance with design. The developer's copy of record will be constructed that Power and Water accepts responsibility for the technical equipment of the design. This responsibility remains absolute with the Developer's electrical Consultant.

This endorsement remains valid for 12 months from the date of issue. Should any changes be made, drawings must be re-submitted for endorsement in accordance with current standards.

Endorsement is subject to the conditions listed below.

Signed: Network Engineering *JWS* Date: 29 Sep 23

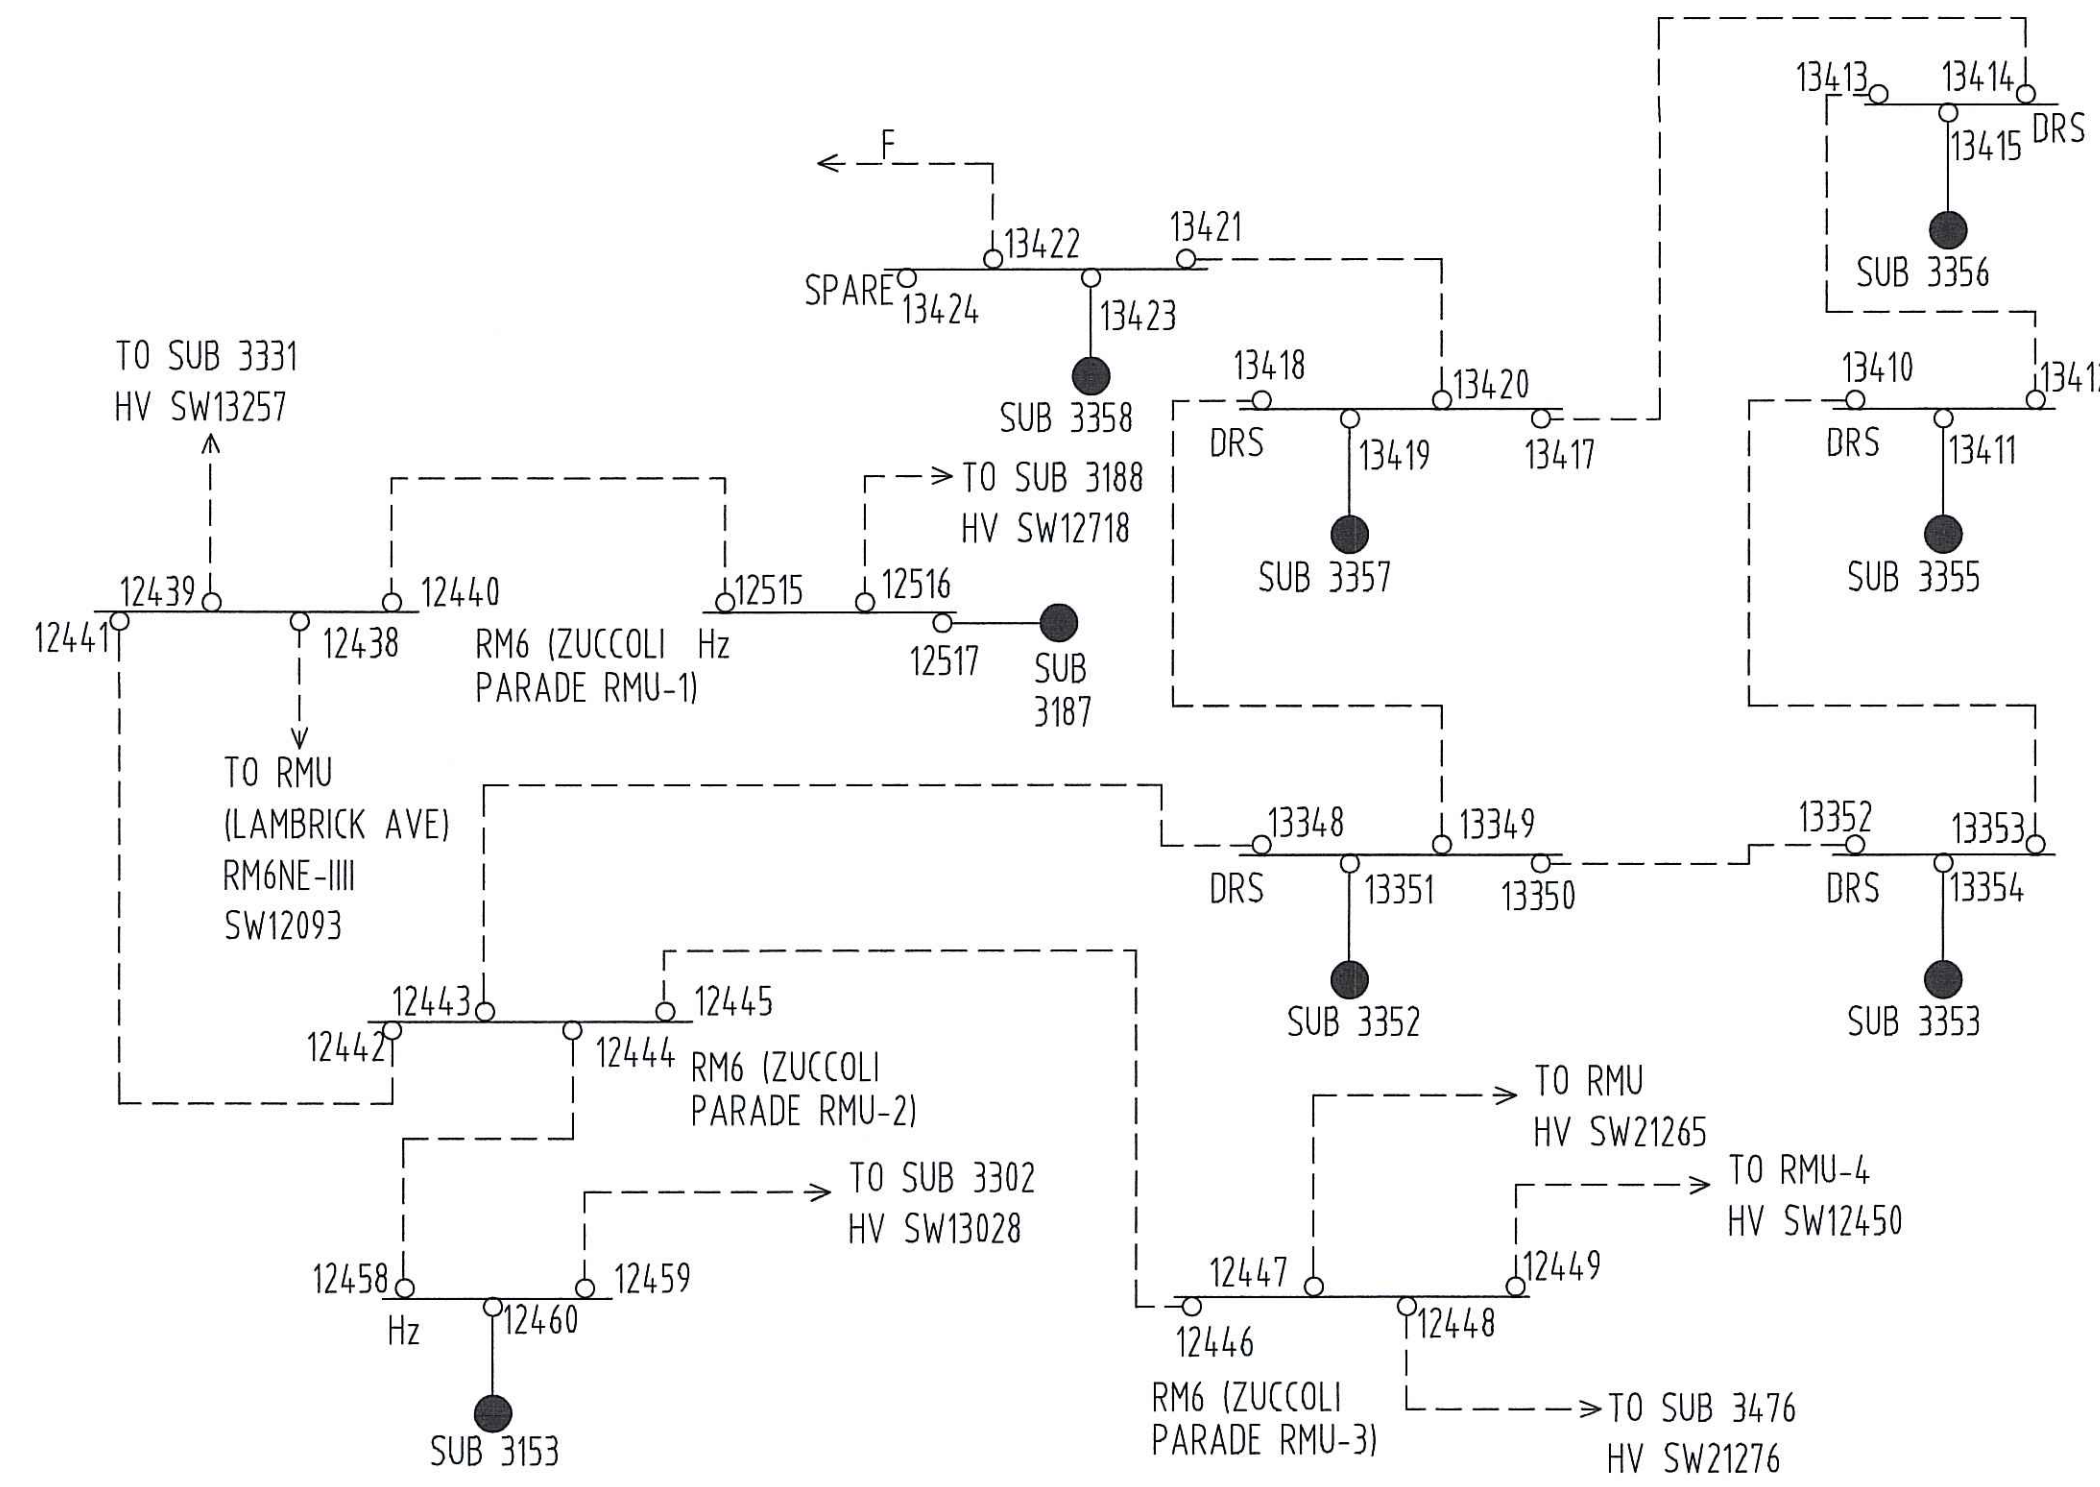


**GIFTED ASSETS**

NOTE - REFER TO DWG No. B23-7110 FOR PILLAR SCHEDULE.

**LEGEND**

- HV SWITCH.
- HV FUSED SWITCH.
- LV STRIPPLE FUSES.
- SUB DISCONNECTOR WITH LINKS.
- DIST. LINK PILLAR OPEN LINKS.
- DIST. LINK PILLAR CLOSED LINKS.
- NEW HV CABLE - 6.35/11kV 3 x 1C 400 Sq mm Al (WATER BLOCKED), XLPE/WBT/SCN/HDPE/NJ/PVC IN 150mm HD uPVC CONDUIT & 1 x 1C 70 Sq mm Cu, BARE EARTH DIRECT BURIED. 'E' INDICATES EXISTING.
- EXISTING HV CABLE - 6.35/11kV 3x1C 240 Sq mm AL (WATER BLOCKED), XLPE/WBT/SCN/HDPE/NJ/PVC (IN HD uPVC CONDUIT) & 1x1C 70 Sq mm Cu, BARE EARTH DIRECT BURIED. 'E' INDICATES EXISTING.
- LV DISTRIBUTION CABLE - 0.6/1kV 4x1C 240 Sq mm AL, XLPE/NJ/PVC - DIRECT BURIED (OR WITHIN CONDUIT AT ROAD CROSSING) & 1x1C 70 Sq mm Cu, BARE EARTH - DIRECT BURIED. ALSO REFER DWG No. B23-7110, NOTE 8. 'E' INDICATES EXISTING.
- FUTURE 3 PHASE LV SERVICE CABLE - BY LOT OWNER.
- EXISTING 3 PHASE LV SERVICE CABLE.
- FUTURE LV SERVICE CABLE - BY LOT OWNER.
- NEW HV CABLE JOINTS - BY POWER AND WATER.

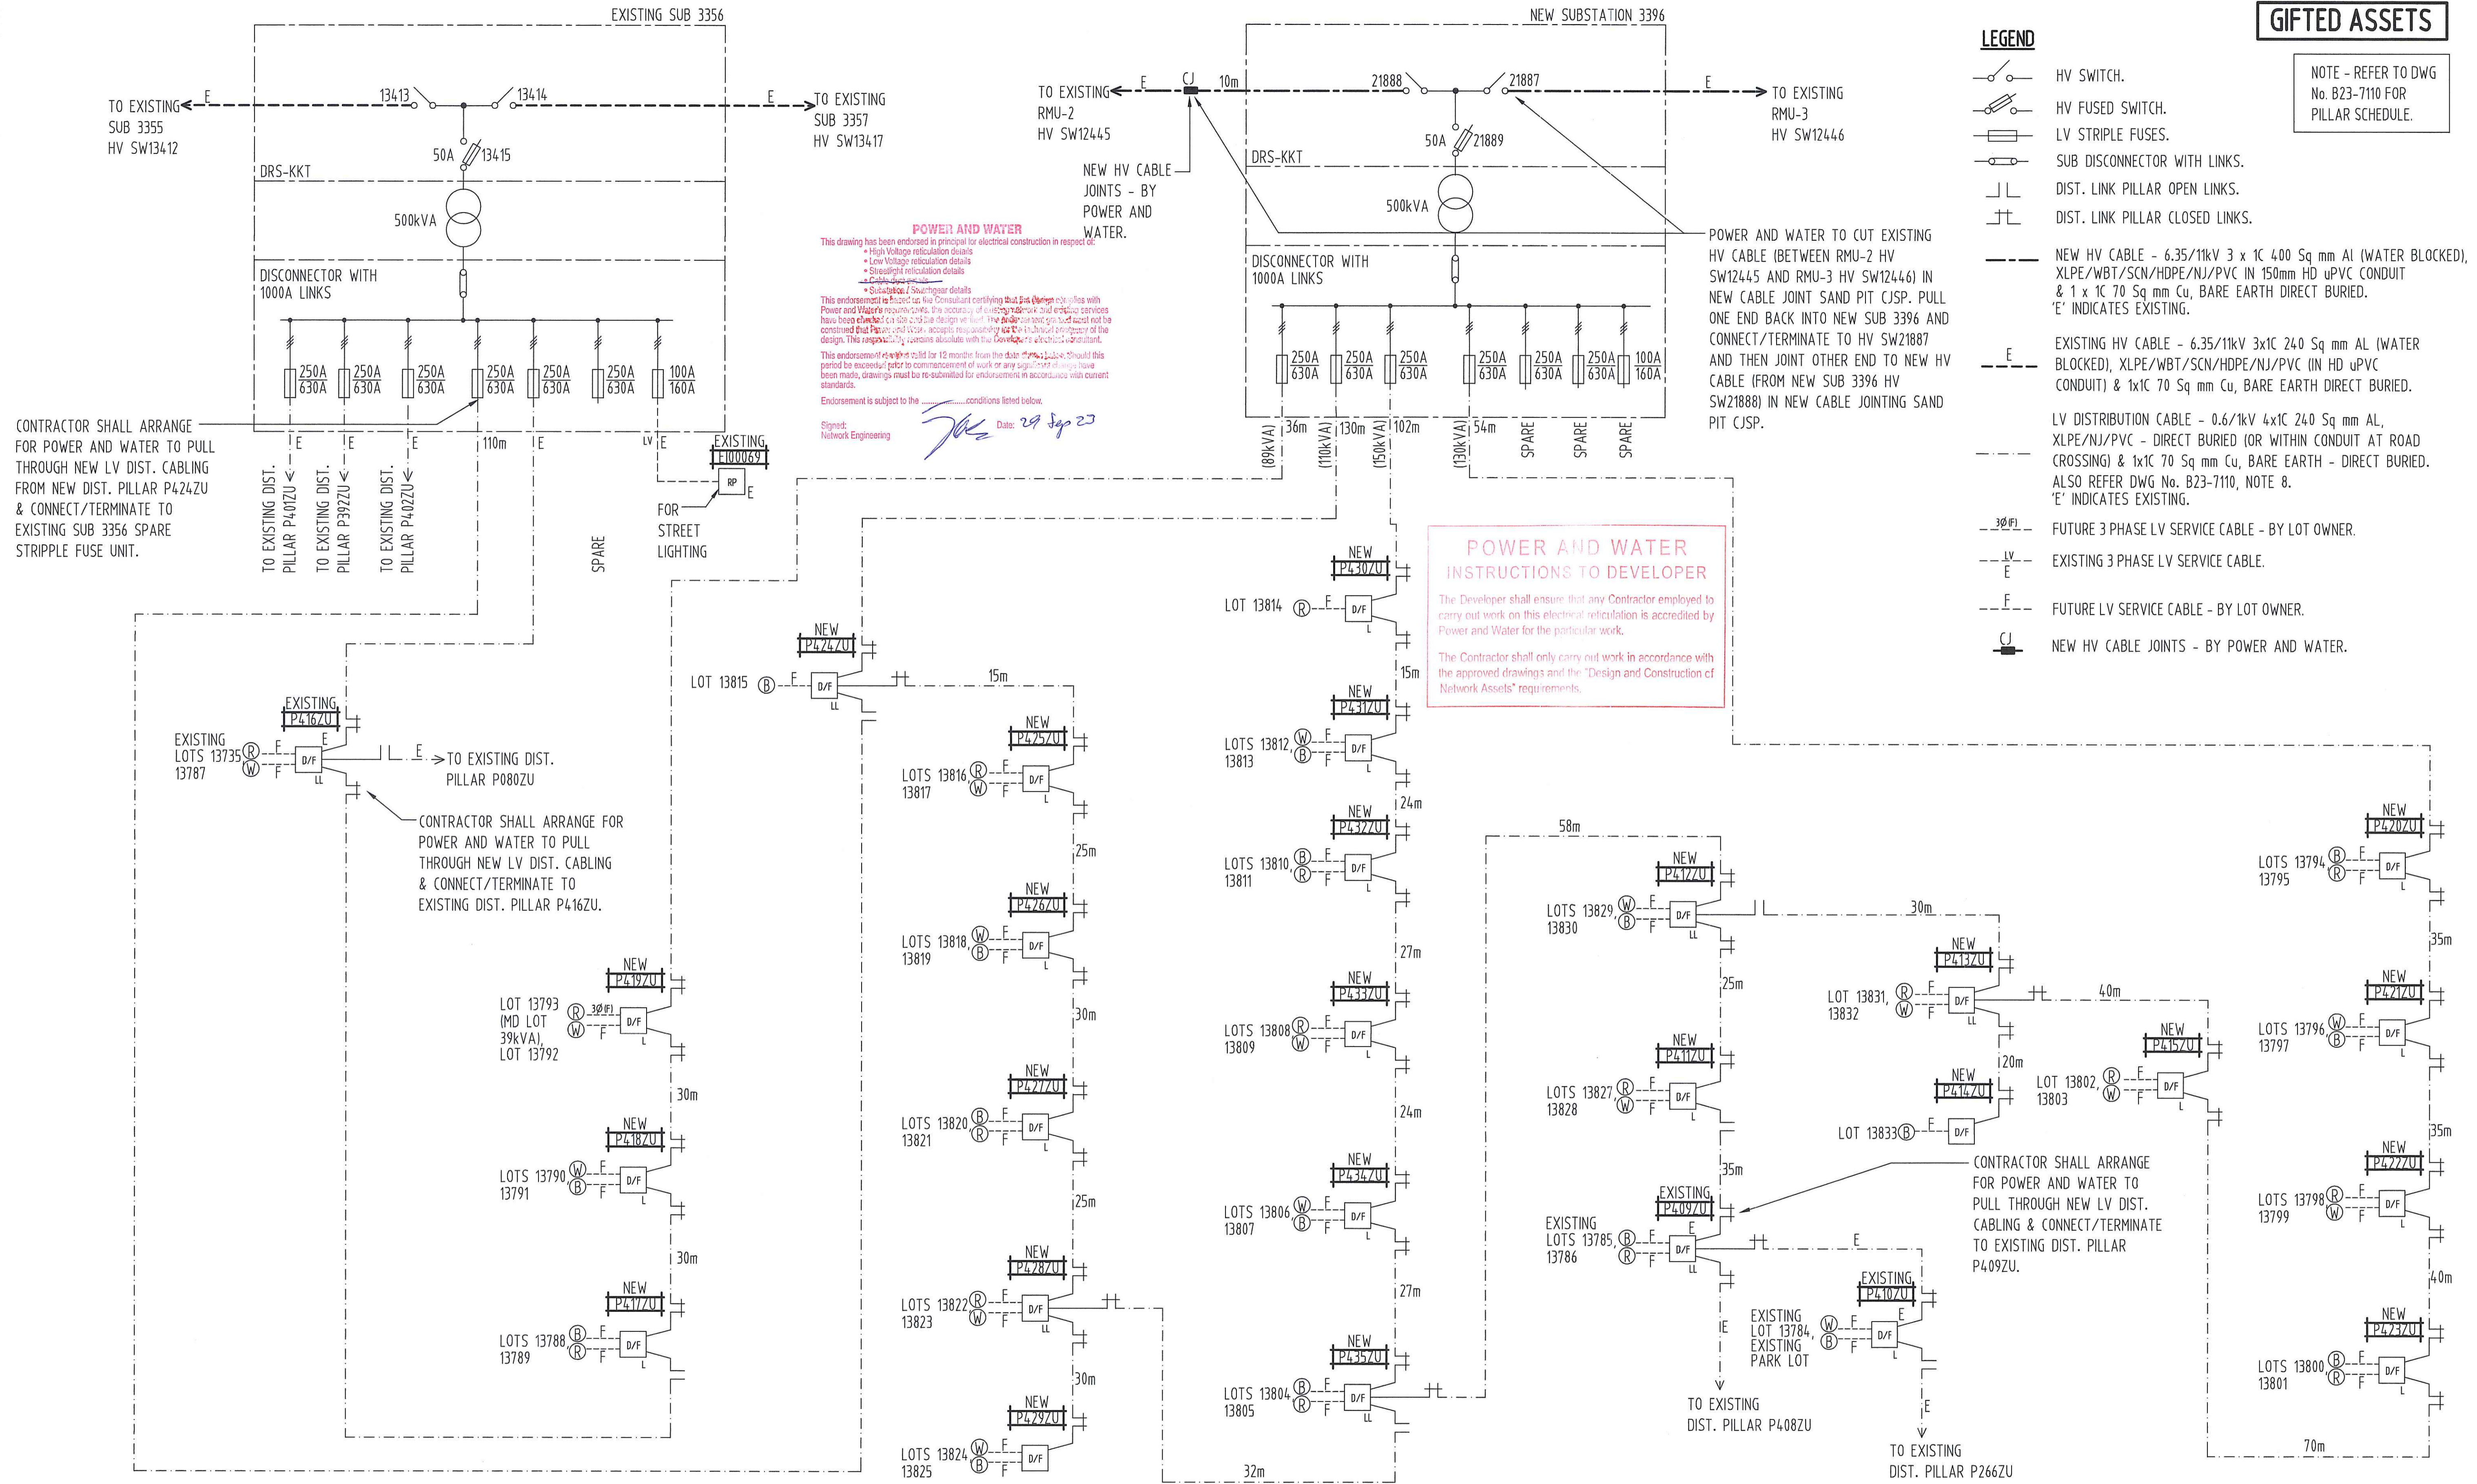

**SINGLE LINE DIAGRAM (N.T.S.)**

DEVELOPER: <b>TERRITORY LIFE</b> GPO Box 1779 DARWIN NT 0801  PHONE: 0417 160700 FACSIMILE: EMAIL: clement.williams@territorylife.com.au CONTACT: CLEMENT WILLIAMS	AGA CONSULTING ENGINEERS PTY LTD ELECTRICAL & MECHANICAL ACN 070 242 286  GPO BOX 3997 DARWIN NT 0801  TELEPHONE: 08 89416582 FACSIMILE: 08 89421400 EMAIL: atekg@agaeng.com.au	E D C B A RE-ISSUED FOR POWER AND WATER APPROVAL RE-ISSUED FOR POWER AND WATER APPROVAL LAYOUT AMENDED ISSUED FOR POWER AND WATER APPROVAL ISSUED FOR POWER AND WATER REVIEW	K.T. 25-9-23 K.T. 15-9-23 K.T. 29-4-23 K.T. 2-6-23 K.T. 9-5-23	A.G. 25-9-23 A.G. 15-9-23 A.G. 29-4-23 A.G. 2-6-23 A.G. 9-5-23	B23-7113 B23-7112 B23-7111 B23-7110 B23-7109	NOTES, SCHEDULES & HV SCHEMATICS MASTER SERVICES PLAN CONDUIT LAYOUT LV ELECTRICAL RETICULATION HV ELECTRICAL RETICULATION	TITLE ASSOCIATED DRAWINGS	AGA406-18A	DRAWING STATUS P PRELIMINARY/PROPOSED T TENDERING PURPOSES ONLY AC APP. FOR CONSTRUCTION AI AS INSTALLED C CANCELLED/SUPERSEDED		APPD	DATE	DES A.GANGUR DRN K.TAVENER CKD A.GANGUR APPD SCALE N.T.S. ISSUED 25-9-23 ALL DIM. IN mm DRAFTING STANDARD TO A.S.1100	POWER SERVICES - PALMERSTON DISTRIBUTION SUBDIVISION OF LOT 12087 ZUCCOLI SUBDIVISION - STAGE 2 : STAGE 2K SINGLE LINE DIAGRAM & LEGEND	A1 DRAWING NUMBER <b>B23-7114</b>	FILE No: NE590/12087 
									AMENDMENTS		NO DESCRIPTION		DRN	DATE	APPD	DRG NO

